CITY OF EL PASO, TEXAS AGENDA ITEM DEPARTMENT HEAD'S SUMMARY FORM

DEPARTMENT: Planning and Inspections Department, Planning Division AGENDA DATE: Introduction: May 30, 2017 Public Hearing: June 27, 2017 CONTACT PERSON/PHONE: Larry Nichols, (915) 212-1550, nicholsif@elpasotexas.gov Jeff Howell, (915) 212-1607, howelljb@elpasotexas.gov **DISTRICT(S) AFFECTED: 3 SUBJECT:** An Ordinance granting Special Permit No. PZST16-00026, to allow for a ground-mounted 56'-10" Personal Wireless Service Facility on the property described as a portion of Lot 27, Block 2, Bassett Commercial Complex Unit One, 6440 Gateway Boulevard East, City of El Paso, El Paso County, Texas, pursuant to Section 20.10.455 of the El Paso City Code. The penalty being as provided in Chapter 20.24 of the El Paso City Code. Subject Property: 6440 Gateway Boulevard East. Property Owner: Gregg Michael Seltzer and Julie Paris Seltzer Trust. PZST16-00026 (District 3) **BACKGROUND / DISCUSSION:** On May 4, 2017, the CPC reviewed and recommended approval of the special permit request. **PRIOR COUNCIL ACTION:** There is no prior City Council action on this special permit application. AMOUNT AND SOURCE OF FUNDING: N/A BOARD / COMMISSION ACTION: City Plan Commission (CPC) - Approval Recommendation (6-0). **LEGAL:** (if required) N/A **FINANCE:** (if required) N/A Larry F. Nichols **DEPARTMENT HEAD:** Director, Planning and Inspection Department APPROVED FOR AGENDA:

DATE:

CITY MANAGER:

ORDINANCE NO.	

AN ORDINANCE GRANTING SPECIAL PERMIT NO. PZST16-00026, TO ALLOW FOR A GROUND-MOUNTED 56'-10" PERSONAL WIRELESS SERVICE FACILITY ON THE PROPERTY DESCRIBED AS A PORTION OF LOT 27, BLOCK 2, BASSETT COMMERCIAL COMPLEX UNIT ONE, 6440 GATEWAY BOULEVARD EAST, CITY OF EL PASO, EL PASO COUNTY, TEXAS, PURSUANT TO SECTION 20.10.455 OF THE EL PASO CITY CODE. THE PENALTY BEING AS PROVIDED IN CHAPTER 20.24 OF THE EL PASO CITY CODE.

WHEREAS, Gregg Michael Seltzer and Julie Paris Seltzer Trust property owners and SBA Towers IX, LLC c/o Shaw & Associates, PLC has applied for a Special Permit under Section 20.04.320 of the El Paso City Code to allow for a ground-mounted Personal Wireless Service Facility (PWSF) that is 56'-10" tall and camouflaged as a pine tree; and,

WHEREAS, the Section 20.10.455 allows for a ground-mounted personal wireless service facility by Special Permit; and,

WHEREAS, a report was made by the City Plan Commission and a public hearing was held regarding such application; and,

WHEREAS, the City Plan Commission has recommended approval of the subject Special Permit; and

WHEREAS, the subject Special Permit has been submitted to the City Council of the City of El Paso for review and approval; and

WHEREAS, the City Council of the City of El Paso finds that the application conforms to all requirements of Section 20.04.320 of the El Paso City Code.

NOW, THEREFORE, BE IT ORDAINED BY THE CITY COUNCIL OF THE CITY OF EL PASO:

1. That the property described as follows, is in a C-3/sc (Commercial/special contract) Zone District:

Portion of Lot 27, Block 2, Bassett Commercial Complex Unit One, 6440 Gateway Boulevard East, City of El Paso, El Paso County, Texas; and as more particularly described by survey and metes and bounds on the attached Exhibit "A"; and,

2. That the City Council hereby grants a Special Permit under Section 20.04.320 of the El Paso City Code to allow for a ground-mounted 56'-10" tall personal wireless service facility on the property described in Paragraph 1 of this Ordinance; and,

PZST16-00026

- 3. Furthermore, the City Council makes the following findings to reduce below onehalf mile the minimum separation distance between ground-mounted PWSF antenna support structures:
 - i. The applicant is reasonably unable to use property that is more than one-half mile from another PWSF antenna support structure and be able to reasonably serve the area designated in a manner that is technically feasible and commercially reasonable;
 - ii. The property on which the PWSF antenna support structure is to be located is the only reasonably available property for use within one-half mile of another PWSF antenna support structure that will enable the applicant to reasonably serve the area designated in a manner that is technically feasible and commercially reasonable;
 - iii. The area designated by the applicant cannot be reasonably served in a manner that is technically feasible and commercially reasonable by locating additional antennas on the applicant's existing PWSF antenna support structures because such existing PWSF antenna support structures cannot safely support additional antennas;
 - iv. The applicant is unable to collocate its antennas on an existing PWSF antenna support structure that is owned or operated by a third person or entity and located such that the applicant is able to reasonably serve the area designated in a manner that is technically feasible and commercially reasonable; and
 - v. The applicant shall submit a list of addresses/locations showing all existing PWSF within a one-half mile radius of the proposed site and a map depicting such locations with the special permit application.
- 4. That this Special Permit is issued subject to the development standards in C-3/sc (Commercial/special contract) District regulations and is subject to the approved Detailed Site Development Plan signed by the Applicant, the City Manager and the Executive Secretary to the City Plan Commission. A copy of this plan is attached hereto as Exhibit "B" and is incorporated herein by reference for all purposes; and,
- 5. That if at any time the Applicant fails to comply with any of the requirements of this Ordinance, Special Permit No. PZST16-00026 shall be subject to termination; construction or occupancy shall be discontinued; and the Applicant shall be subject to the penalty provisions of Chapter 20.24 and any other legal or equitable remedy; and,
- 6. That the Applicant shall sign an Agreement incorporating the requirements of this Ordinance. Such Agreement shall be signed and filed with the Zoning

building permits are issued.

Administrator and the Executive Secretary to the City Plan Commission before

AGREEMENT

Gregg Michael Seltzer and Julie Paris Seltzer Trust (Property Owner) and SBA Towers IX, LLC c/o Shaw & Associates, PLC referred to in the above Ordinance, hereby agrees to develop the above-described property in accordance with the approved Detailed Site Development Plan attached to same Ordinance, and in accordance with the standards identified in the C-3 (Commercial/special contract) District regulations, and subject to all other requirements set forth in this Ordinance.

EXECUTED 23rd day of May, 2017.

Gregg Michael Seltzer and Julie Paris Seltzer Trust

By: Mann S. Schwartz, V.P. and Associate General Counsel, Legal Operations, SBA Towers IX, LLC, on behalf of Gregg Michael Seltzer and Julie Paris Seltzer Trust, property owner. See attched authorization.

ACKNOWLEDGMENT

THE STATE OF FLORIDA) COUNTY OF PALM BEACH

This instrument is acknowledged before me on this 23rd day of may, 2017, by Sharon S. Schwartz, Vice President and Associate General Counsel, Legal Operations for SBA Towers IX, LLC, a Delaware limited liability company, agent for Gregg Michael Seltzer and Julie Paris Seltzer Trust, property owner, made in connection with the attached limited power of attorney.

RICHARD KASSER

Notary Public – State of Florida

Commission # GG 088914

My Comm. Expires Jul 25, 2021

My Commission Expires:

JULY 25, 2021

Notary Public, State of Florida Signature

Printed or Typed Name

(Signature)

(Name/Title)

TO CITY OF EL PASO PLANNING AND INSPECTIONS DEPARTMENT

This letter will serve as authorization for SBA TOWERS IX, LLC and/or its agent(s) to act as an agent on behalf of the <u>Gregg Michael Seltzer and Julie Parist</u> <u>Seltzer Trust</u>, including but not limited to, power of attorney for the purpose of obtaining a Special Permit, Site Plan Review and Building Permit, for the proposed wireless communications facility (WCF). The proposed WCF project name is ELP Clark.

Construction of the proposed wireless communications facility will not commence unless and until all of the necessary permits are obtained.

LAND OWNER: GREGG MICHAEL SELTZER & JULIE PARIS

SELTZER TRUST DATED DECEMBER 30, 1992

Subject parcel is PID# B23599900208400 Subject parcel address: 6440 Gateway Boulevard East, El Paso, TX 79905

LAND OWNER: GREGG MICHAEL SELTZER & JULIE PARIS

SELTZER TRUST DATED DECEMBER 30, 1992

By: Gregg Michael Seltzer Title: Trustee	By: Julie Paris Seltzer Title: Trustee
Date:	Date: 7/16/2016
	Extended to the second of the
Notary Public:	Notary Public:
I do hereby certify that <u>Greed M. Geltan</u> , who is personally known to me, or who has proved by sufficient evidence to be the person named herein, personally appeared before me this day and acknowledged the due execution of the foregoing instrument.	I do hereby certify that Tylic laws settarwho is personally known to me, or who has proved by sufficient evidence to be the person named herein, personally appeared before me this day and acknowledged the due execution of the foregoing instrument.
Witness my hand and seal thisday of, 20	Witness my hand and seal this day of, 20
SEE ATT	TACHED NOTARY
Notary Signature	Notary Signature

CALIFORNIA ALL-PURPOSE ACKNOWLEDGMENT

CIVIL CODE § 1189

ekekekekekekekekekekekekek

A notary public or other officer completing this certificate verifies only the identity of the individual who signed the document to which this certificate is attached, and not the truthfulness, accuracy, or validity of that document.

State of California	
County of Los ringeres)	
County of Los Angeles) On September 16, 2016 before me, Lis	sa Marie Seltzer, Notarytubl
Date	Here Insert Name and Litle of the Officer
personally appeared Grego M. S	Seltzer and
	Name(s) of Signer(s)
Julie Paris	Seltzer
	vidence to be the persons whose names is are
subscribed to the within instrument and acknowled	dged to me that he/she/the) executed the same in her/their signature on the instrument the person signature.
of	certify under PENALTY OF PERJURY under the laws the State of California that the foregoing paragraph true and correct.
W	TITNESS my hand and official seal.
LISA MARIE SELTZER Commission # 2141393 Notary Public - California Los Angeles County My Comm. Expires Feb 2, 2020	gnature Signature of Notary Public
Place Notary Seal Above	
OPTI	ONAL —
Though this section is optional, completing this in fraudulent reattachment of this fo	formation can deter alteration of the document or or or or an unintended document.
Description of Attached Document	
Title or Type of Document:	Document Date:
Number of Pages: Signer(s) Other Than	Named Above:
Capacity(ies) Claimed by Signer(s)	
Signer's Name:	Signer's Name:
☐ Corporate Officer — Title(s):	☐ Corporate Officer — Title(s):
□ Partner - □ Limited □ General	□ Partner — □ Limited □ General□ Individual □ Attorney in Fact
☐ Individual ☐ Attorney in Fact ☐ Guardian or Conservator	☐ Trustee ☐ Guardian or Conservator
Other:	Other:
Signer Is Representing:	Signer Is Representing:

Exhibit A



POSITION OF GEODETIC COORDINATES
LATITUDE 31' 46' 53.2" NORTH (NAD83)
LONGITUDE 106' 24' 05.7" VEST (NAD83)
GROUND ELEVATION © 3858.3' (NAVD88)

SURVEY DATE

BASIS OF BEARING
BEARINGS SHOWN HEREON ARE BASED UPON U.S. STATE PLANE NADB3 COORDINATE SYSTEM TEXAS
STATE PLANE COORDINATE ZONE CENTRAL, DETERMINED BY GPS OBSERVATIONS.

PROJECT ELEVATIONS ESTABLISHED FROM GPS DERIVED ORTHOMETR'C HEIGHTS BY APPLICATION OF NGS
'GEOID 12B' MODELED SEPARATIONS TO ELLIPSOID HEIGHTS DETERMINED BY RAW STATIC GPS DATA
PROCESSED ON THE NGS OPUS WEBSITE, ALL ELEVATIONS SHOWN HEREON ARE REFERENCED TO
NAVOBB.

FLOOD ZONE
THIS PROJECT APPEARS TO BE LOCATED WITHIN FLOOD ZONE "X". AREAS DETERMINED TO BE OUTSIDE
THE 0.2% ANNUAL CHANCE FLOODPLAIN ACCORDING TO FEDERAL EMERGENCY MANAGEMENT AGENCY
FLOOD INSURANCE RATE MAP, MAP ID #4802140035B. DATED 10/15/1982

UTILITY NOTES
SURVEYOR DOES NOT GUARANTEE THAT ALL UTILITIES ARE SHOWN OR THER LOCATIONS ARE DEFINITE.
IT IS THE RESPONSBULTY OF THE CONTRACTOR AND DEVELOPER TO CONTACT BLUE STAKE AND ANY
OTHER INVOLVED AGENCIES TO LOCATE ALL UTILITIES PRIOR TO CONSTRUCTION. REMOVAL, RELOCATION AND/ OR REPLACEMENT IS THE RESPONSIBILITY OF THE CONTRACTOR

SURVEYOR HAS NOT PERFORMED A SEARCH OF PUBLIC RECORDS TO DETERMINE ANY DEFECT IN TITLE

THE BOUNDARY SHOWN HEREON IS PLOTTED FROM RECCRD INFORMATION AND DOES NOT CONSTITUTE A BOUNDARY SURVEY OF THE PROPERTY.


ALL DISTANCES SHOWN HEREON ARE GRID DISTANCES.

LESSOR'S LEGAL DESCRIPTION

A PORTION OF LOT 27. BLOCK 2, BASSETT COMMERCIAL COMPLEX UNIT ONE. AN ADDITION TO THE CITY OF EL PASO, EL PASO COUNTY, TEXAS, ACCORDING TO THE PLAT THEREOF ON FILE IN VOLUME 18, PAGE 44, PLAT RECORDS, EL PASO COUNTY, TEXAS, AND BEING VORE PARTICULARLY DESCRIBED BY METES AND BOUNDS AS FOLLOWS:

METES AND BOUNDS AS FOLLOWS:

COMMENCING FOR REFERENCE AT A FOUND 1/2" REBAR ON THE SOUTHEASTERLY CORNER OF LOT 26, BLCCK 2, SAD POINT ALSO BEING ON THE INTERSECTION OF THE NORTH-ERLY AND EASTERLY LINE OF AN EXISTING 20" ALLEY THENCE LEAVING SAD LINE SOUTH 09'33'20" EAST A DISTANCE OF 20.00 FEET TO A POINT ON THE SOUTHERLY LINE OF AN EXISTING 20" ALLEY, THENCE ALONG SAID ALLEY NORTH 80'26'40" EAST A DISTANCE OF 22 FEET TO A POINT ON THE COMMON LINE OF LOTS 26 & 27, BLOCK 24. THENCE ALONG SAID LINE SOUTH 09'33'20" EAST A DISTANCE OF 15:00 FEET TO FOUND 1/2" REBAR CN SAID COMMON LINE AND THE NORTHERLY RICHT OF WAY LINE OF CLARK ROAD (60' R.O.W.). THENCE ALONG SAD LINE NORTH 80' 26' 40' EAST A DISTANCE OF 15:79 FEET TO A FOUND 5/8" REBAR WITH CAP MARKED CONDE INC. TX 2665 FOR THE TRUE POINT OF BEGINNING; THENCE CONTINUING ALONG SAID LINE NORTH 80' 26' 40" EAST A DISTANCE OF 19.21 FEET TO A FIND 5/8" REBAR WITH CAP MARKED CONDE, INC. TX 2665 FOR THE TRUE POINT OF BEGINNING; THENCE CONTINUING ALONG SAID LINE NORTH 80'26' 40" EAST A DISTANCE OF 19.21 FEET TO A FIND 5/8" REBAR WITH CAP MARKED CONDE, INC. TO UNIFINISHED FURNITURE CENTER INC IN VOLUME 923, PAGE 688, DEED RECORDS OF EL PASO COUNTY, TEXAS, THENCE ALONG SAID LINE NORTH 69'23'20" WEST A DISTANCE OF 95.00 FEET TO A FOUND 5/8" REBAR WITH CAP MARKED CONDE, INC. TX 2665: THENCE NORTH C9'33'20" WEST A DISTANCE OF 18.2 FEET TO A FOUND 5/8" REBAR WITH CAP MARKED CONDE, INC. TX 2665: THENCE NORTH C9'33'20" WEST A DISTANCE OF 18.2 FEET TO A FOUND 5/8" REBAR WITH CAP MARKED CONDE, INC. TX 2665: THENCE NORTH SO'35'20" WEST A DISTANCE OF 18.2 FEET TO A FOUND 5/8" REBAR WITH CAP MARKED CONDE, INC. TX 2665: THENCE NORTH SO'35'20" WEST A DISTANCE OF 18.2 FEET TO A FOUND 5/8" REBAR WITH CAP MARKED CONDE, INC. TX 2665: THENCE ALONG SAID LINE NORTH SO'36'50" EAST A DISTANCE OF 18.45 FEET TO A FOUND 5/8" CAST A DISTANCE OF 18.45 FEET TO A FOUND 5/8" REBAR WITH CAP MARKED CONDE, INC. TX 2665 ON THE SOUTH SISTING OF 30.00 THE SOUTH SISTING OF 30.00 THE SOUTH SISTING OF 30.00 TH

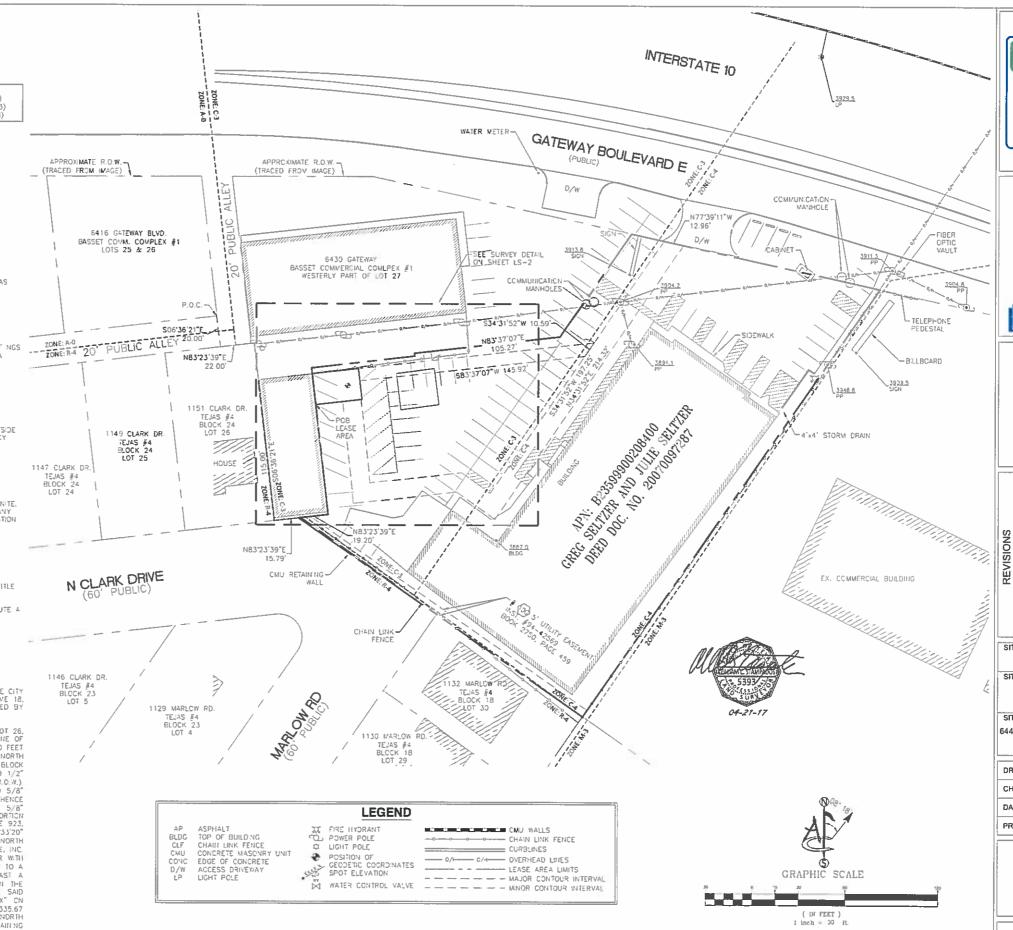

ڪ ×윤: ⋖ m S

esign Ŋ SiinoD

91991

-		-		_	_	_		_	-
			RC	ED.	RC	č	RC	8	
	DESCRIPTION	PRELIMINARY	TITLE REPORT (C)	ADD DESIGN (C)	COMMENTS (C)	REVISE UTILITY ESWIT (C) CK	REV SCHED."B" NOTE(C) RC	COUMENTS & REVISIONS(C)	REY, ZONING LIMITS(C) RC
	DATE	03/02/16	04/20/16	04/26/16	05/10/16	07/15/16	01/31/17	04/11/17	04/21/17
	NO.	4		2	23	학	2	6	7

SITE I.D. TX17739-B SITE NAME:

ELP CLARK

SITE ADDRESS:

6440 GATEWAY BOULEVARD E EL PASO, TX 79905

DRAWN BY:	СК
CHECKED BY:	SB
DATE:	03/02/16
PROJECT #:	TED

SHEET TITLE:

SITE SURVEY

SHEET NO.

LS-1

LEASE AREA LEGAL DESCRIPTION

A PORTION OF DEED DOCUMENT NO. 20070097287, EL PASO COUNTY RECORDS, TEXAS: ALSO BEING A PORTION OF LOT 27. BLOCK 2. BASSETT COMMERCIAL PASO COUNTY, TEXAS, AND BEING MORE PARTICULARLY DESCRIBED BY METES AND BOUNDS AS

COMMENCING FOR REFERENCE AT THE SOUTHEASTERLY CORNER OF LOT 26, BLOCK 2, SAID POINT ALSO BEING ON THE INTERSECTION OF THE NORTHERLY AND EASTERLY LINE OF AN EXISTING 20' ALLEY THENCE LEAVING SAID LINE SOUTH BG'36'21' FAST A DISTANCE OF 20.00 FEET TO A POINT ON THE SOUTHERLY LINE OF AN EXISTING 20' ALLEY; THENCE ALONG SAID ALLEY NORTH B3'23'39' EAST A DISTANCE OF 22.00 FEET TO THE POINT ON THE COMMON LINE OF LOTS 28 & 27, BLOCK 24; THENCE ALONG SAID LINE SOUTH OB'35'21' EAST A DISTANCE OF 115.00 FEET TO THE THE CONTROL OF SAID COMMON LINE OF LOTS 20 & 27, STOCK Z4; HENCE ALONG SAID LINE SDUTH 65'35'21" EAST A DISTANCE OF 115.00 FEET TO THE INTERSCRICTION OF SAID COMMON LINE AND THE NORTHERLY RIGHT OF WAY LINE OF CLARK ROAD (60' R.O.W.); THENCE ALONG SAID LINE NORTH 83' 23' 39" EAST A DISTANCE OF 15.79 FEET; THENCE CONTINUING ALONG SAID LINE NORTH 83'23'39" EAST A DISTANCE OF 19.20 FEET TO THE EASTERLY LINE OF "SAVE AND EXCEPT" PORTION FROM POPULAR MANUFACTURING CORP. INC. TO UNFINISHED FURNITURE CENTER INC. IN YOLUME 923, PAGE 688, DEED RECORDS OF EL PASO COUNTY, TEXAS; THENCE ALONG SAID LINE NORTH 06'36'21" WEST A DISTANCE OF 71.18 FEET TO THE POINT OF BEGINNING; THENCE CONTINUING NORTH 06'36'21" WEST, 20.00 FEET; THENCE NORTH 83'23'39" EAST, 30.00 FEET; THENCE SOUTH 83'23'39" WEST, 30.00 FEET TO THE POINT OF BEGINNING.

CONTAINING 600 SQUARE FEET (0.014 ACRES) OF LAND, MORE OR LESS.

ACCESS FASEMENT LEGAL DESCRIPTION

A PORTION OF DEED DOCUMENT NO. 20070097287. EL PASO COUNTY RECORDS, TEXAS: ALSO BEING A PORTION OF LOT 27, BLOCK 2, BASSETT COMMERCIAL COMPLEX UNIT ONE, AN ADDITION TO THE CITY OF EL PASO, EL PASO COUNTY, TEXAS, ACCORDING TO THE PLAT THEREOF ON FILE IN VOLUME 18, PAGE 44, PLAT RECORDS, EL PASO COUNTY, TEXAS, AND BEING MORE PARTICULARLY DESCRIBED BY METES AND BOUNDS AS

COMMENCING FOR REFERENCE AT THE SOUTHEASTERLY CORNER OF LOT 26, BLOCK 2, SAID POINT ALSO BEING ON THE INTERSECTION OF THE NORTHERLY AND EASTERLY LINE OF AN EXISTING 20' ALLEY THENCE LEAVING SAID LINE SOUTH 06'35'21" EAST A DISTANCE OF 20.00 FEET TO A POINT ON THE SOUTHERLY LINE OF AN EXISTING 20' ALLEY THENCE ALONG SAID ALLEY BOOTH 83'23'39" EAST A DISTANCE OF 22.00 FEET TO A POINT ON THE COMMON LINE OF LOTS 26 & 27, BLOCK 24; THENCE ALONG SAID LINE SOUTH 06'35'21" EAST A DISTANCE OF 115.00 FEET TO THE INTERSECTION OF SAID COMMON LINE AND THE NORTHERLY RIGHT OF WAY LINE OF CLARK ROAD (60' R.O.W.): THENCE ALONG SAID LINE NORTH 83'23'39" EAST A DISTANCE OF 19.20 FEET TO THE EASTERLY LINE OF "SAYE AND EXCEPT" PORTION FROM POPULAR MANUFACTURING CORP. INC. TO UNFINISHED FURNITURE CENTER INC. IN VOLUME 923, PACE 68B. DEED RECORDS OF EL PASO COUNTY, TEXAS; THENCE ALONG SAID LINE NORTH 06'36'21" AEST A DISTANCE OF 71.18 FEET; THENCE DEPARTING SAD LINE, NORTH 83'23'39" EAST A DISTANCE OF 71.18 FEET; THENCE DEPARTING SAD LINE, NORTH 83'23'39" EAST A DISTANCE OF 19.20 FEET TO THE POINT OF RECONNING; THENCE SOUTH 06'16'05' EAST 64.05 FEET THENCE EXPIRIT BASTER'S FEAT THE ASTINGE PAST 24.05 FEET; THENCE EXPIRIT BASTER'S FEAT THENCE SOUTH 63'16'05' EAST 64.05 FEET, THENCE EXPIRIT BASTER'S FEAT TO ALS FEET. THENCE EXPIRIT BASTER'S FEAT THENCE SOUTH 63'16'05' FAST 164.05 FEET, THENCE EXPIRIT BASTER'S FAST 30'15 FEET TO THE POINT OF RECONNING; THENCE SOUTH 06'16'05' EAST 64.05 FEET, THENCE EXPIRIT BASTER'S FAST 30'15 FERTENCE AND FAST 30'15 FEET TO THE POINT OF RECONNING; THENCE SOUTH 06'16'05' FAST 164.05 FEET, THENCE EXPIRIT BASTER'S FAST 30'15 FEET THENCE MOBILE OF THE PROPRIET OF THE PART ASTAT 30'15 FEET THENCE PART ASTAT 30'15 FEET TO THE POINT OF RECONNING; THENCE SOUTH 05'16'05' FAST 164.05 FEET THE PART BAST 30'15 FEET TO THE POINT OF RECONNING; THENCE SOUTH 05'16'05' FAST 164.05' FAST 164.0 THENCE NORTH B334-55 EAST 67.04 FEET; THENCE SOUTH 5438-26 EAST 30.13 FEET; THENCE NORTH 3431-52 EAST 214.32 FEET; THENCE NORTH 77/39/11 WEST 12.95 FEET; THENCE SOUTH 3431-52 WEST, 197.25 FEET; THENCE NORTH 5438-26 WEST, 22.53 FEET; THENCE SOUTH 83/34-55 WEST 59.59 FEET; THENCE NORTH 06/16/06 WEST 54.10 FEET; THENCE SOUTH 83/25/39 WEST 12.00 FEET TO THE POINT OF BEGINNING.

CONTAINING 2,486 SQUARE FEET (0,057 ACRES) OF LAND, MORE OR LESS.

UTILITY EASEMENT LEGAL DESCRIPTION
A PORTION OF DEED DOCUMENT NO. 20070007287, EL PASO COUNTY RECORDS, IEXAS: ALSO BEING A PORTION OF LDT 27. BLOCK 2.
BASSETT COMMERCIAL COMPLEX UNIT ONE, AN ADDITION TO THE CITY OF EL PASO, EL PASO COUNTY, TEXAS, ACCORDING TO THE PLAT THEREOF OF
FILE IN YOLUME 18, PAGE 44, PLAT RECORDS, EL PASO COUNTY, TEXAS, AND BEING MORE PARTICULARLY DESCRIBED BY METES AND BOUNDS AS

COMMENCING FOR REFERENCE AT THE SOUTHEASTERLY CORNER OF LOT 26, BLOCK 2, SAID POINT ALSO BEING ON THE INTERSECTION OF THE NORTHERLY AND EASTERLY LINE OF AN EXISTING 20' ALLEY THENCE LEAVING SAID LINE SOUTH 06'38'21' EAST A DISTANCE OF 20.00 FEET TO A POINT ON THE SOUTHERLY LINE OF AN EXISTING 20' ALLEY, THENCE ALONG SAID LINE SOUTH 06'38'21' EAST A DISTANCE OF 12.00 FEET TO A POINT ON THE COMMON LINE OF LOTS 26 & 27, BLOCK 24' THENCE ALONG SAID LINE SOUTH 06'38'21' EAST A DISTANCE OF 15.00 FEET TO THE INTERSECTION OF SAID COMMON LINE AND THE NORTHERLY RIGHT OF WAY LINE OF CLARK ROAD (60' R.O.W.); THENCE ALONG SAID LINE NORTH 83'23'39' EAST A DISTANCE OF 19.20 FEET TO THE EASTERLY LINE OF "SAVE AND EXCEPT" PORTION FROM POPULAR MANUFACTURING CORP. INC. TO UNFINISHED FURNITURE CENTER INC, IN VOLUME 923, PACE 688, DEED RECORDS OF EL PASD COUNTY, TEXAS; THENCE ALONG SAID LINE NORTH 65'21' WEST A DISTANCE OF 91.18 FEET; THENCE NORTH 63'23'39' EAST AS OFFER TO THE POINT OF BEGINNING; THENCE NORTH 83'35'07' EAST 4.00G SAID NORTH LINE, 5.00 FEET; THENCE LOPARTING SAID LINE NORTH 85'23'39' EAST ALONG SAID NORTH LINE, 5.00 FEET; THENCE DEPARTING SAID HORTH LINE SCUTH 06'22'53' EAST, 5.83 FEET; THENCE NORTH 83'37'07' EAST, LONG SAID NORTH LINE, 5.00 FEET; THENCE DEPARTING SAID HORTH LINE SCUTH 06'32'53' EAST, 5.83 FEET; THENCE NORTH B3'33'707' EAST, 105.27 FEET TO AN ACCESS AND UTILITY EASEMENT, THENCE SOUTH 34'31'52' WEST ALONG SAID NORTH LINE, 5.00 FEET; THENCE DEPARTING SAID HORTH LINE SOUTH 63'33'67' WEST ALONG SAID NORTH LINE, 5.00 FEET; THENCE NORTH 06'36'21' EAST ALONG SAID NORTH LINE, 5.00 FEET; THENCE NORTH 06'36'21' WEST ALONG SAID NORTH LINE, 5.00 FEET; THENCE NORTH 06'36'21' EAST ALONG SAID NORTH LINE, 5.00 FEET; THENCE NORTH 06'36'21' EAST ALONG SAID NORTH LINE, 5.00 FEET; THENCE NORTH 06'36'21' EAST ALONG SAID NORTH LINE, 5.00 FEET; THENCE NORTH 06'36'21' EAST ALONG SAID NORTH LINE, 5.00 FEET; THENCE NORTH 06'36'21' EAST ALONG SAID NORTH LINE, 5.00 FEET; THENCE NORTH 06'36'21' EAST ALONG SAID NORTH LINE, 5.00 FEET: THENCE NORTH 06'36'21" EAST 8 00 FEET TO THE POINT OF BEGINNING.

CONTAINING 1,929 SQUARE FEET (0.043 ACRES) OF LAND, MCRE OR LESS.

REFERENCE IS MADE TO THE TITLE REPORT ORDER #16029254, ISSUED BY OLD REPUBLIC TITLE INSURANCE COMPANY, DATED MARCH 30, 2016. ALL EASEMENTS CONTAINED WITHIN SAID TITLE REPORT AFFECTING THE IMMEDIATE AREA SURROUNDING THE LEASE HAVE BEEN PLOTTED.

ITEMIZED NOTES: SCHEDULE "8" ITEM NUMBERS 1 THROUGH 9 AS WELL AS 10A THROUGH 10E AND 10L THROUGH 10N ARE NOT SURVEY MATTERS, OR, HAVE NO EFFECT IN THE AREA OF THIS SURVEY. 10F TELEPHONE EASEMENT RECORDED IN BOOK 1257, PACE 359 REAL PROPERTY RECORDS OF EL PASO COUNTY, TEXAS - UNABLE TO DELINEATE

- UTILITY EASEMENT RECORDED AS INSTRUMENT NUMBER 94-42569 IN BOOK 2750, PAGE 459 REAL PROPERTY RECORDS OF EL PASO COUNTY, TEXAS SHOWN AND NOTED HEREON, NO CONFLICT WITH LEASE AREA
- 10H DELETED FROM REPORT NOTHING TO SHOW
- 10# ELECTRIC EASEMENT RECORDED MARCH 23, 2006 AS INSTRUMENT NUMBER 20050026087, OFFICIAL PUBLIC RECORDS OF EL PASO COUNTY, TEXAS LIES TO THE EAST BEYOND THE SCOPE OF THIS SURVEY, NO CONFLICT WITH LEASE AREA
- 10. ELECTRIC EASEMENT RECORDED SEPTEMBER 10, 2003 AS INSTRUVENT NUMBER 20030088038 IN BOOK 4677, PAGE 842, OFFICIAL PUBLIC RECORDS OF EL PASO COUNTY, TEXAS LIES TO THE EAST BEYOND THE SCOPE OF THIS SURVEY, NO CONFLICT MITH LEASE AREA
- 10K CONTRACT FOR REZONING AND RESTRICTIONS RECORDED IN BOOK 492, PAGE 1351 AND IN BOOK 656, PAGE 8, REAL PROPERTY RECORDS OF EL PAGO COUNTY, TEXAS NOT A SURVEY WATTER, NOTHING TO SHOW

SURVEYOR'S CERTIFICATION

HEREBY CERTIFY TO SBA TOWERS IX. LLC, A DELAWARE LIMITED LIABLITY COMPANY AND OLD REPUBLIC NATIONAL TITLE INSURANCE COMPANY, THE


THIS SURVEYOR HAS RECEIVED AND REFERVED THAT CERTAIN TITLE REPORT COMMITMENT NO. 16029254, ISSUED BY OLD REPUBLIC NATIONAL TITLE INSURANCE COMPANY WITH AN EFFECTIVE DATE OF MARCH 30, 2016 WHICH PROPOSES TO INSURE THE LANDS DESCRIBED UNDER ITS SCHEDULE A.

THS SURVEYOR KNOWS OF HIS OWN KNOWLEDGE THAT THE LANDS DESCRIBED UNDER SAID SCHEDULE A OF THE TITLE COMMITMENT CONTAIN OR INCLUDE THE LANDS DESCRIBED IN AND DEPICTED ON THIS SURVEY.

CAS TO SEE BUUCHOS ROUND DETITING ON CARD TO STANDARD THE SUBJECT SENT OF STANDARD SHIP ROYAND SHIP STANDARD OF ST PARCELS. THERE MAY BE POSSIBLE CONFLICTS WITH TITLE REPORT EXCEPTION \$10F.

FURTHER CERTIFY THAT ALL PARTS OF THIS SURVEY AND DRAWING HAVE BEEN COMPLETED IN ACCORDANCE WITH THE CURRENT REQUIREMENTS OF THE STANDARDS OF PRACTICE FOR SURVEYING IN THE STATE OF TEXAS TO THE BEST OF MY KNOWLEDGE, MFORMATION, AND BELIEF.

WILLIAM C. STAMPADOS, R.P.L.S. 5393 DATE

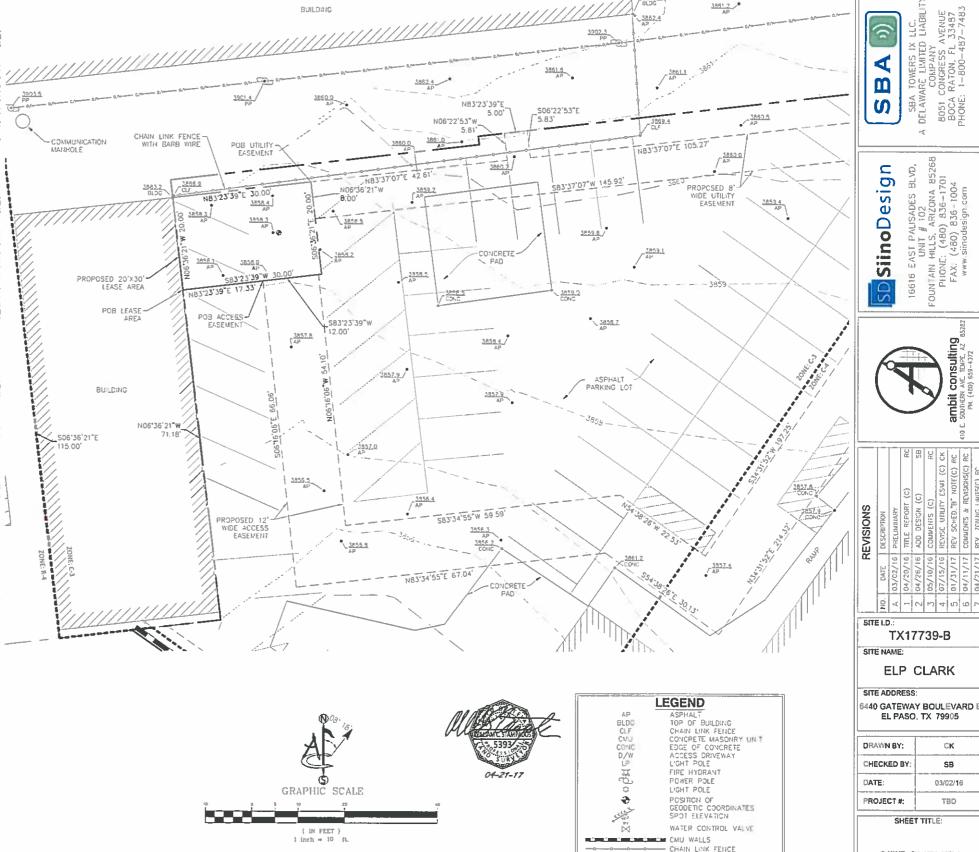

હ

⋖

m

S

6

·Si

O

SiinoD

| 6616 EAST PALISADES BLVD UNIT # 102 UNIT # 102 PHONE: (480) 836-1701 FAX: (480) 836-1004 www.sinodesign.com

91991

TX17739-B

ELP CLARK

EL PASO, TX 79905

SHEET TITLE

SITE SURVEY

SHEET NO.

LS-2

CURBLINES

--- - MINOR CONTOUR INTERVAL

O/I---- OVERHEAD LINES -- LEASE AREA LIMITS - - - - - - MAJOR CONTOUR INTERVAL CK

SB

03/02/16

TBD



Building Better Wireless®

SBA TOWERS IX LLC. A DELAWARE LIMITED LIABILITY COMPANY 8051 CONGRESS AVENUE BOCA RATON, FL 33487 PHONE: 1-800-487-7483

> SITE NAME ELP CLARK

SITE I.D. TX17739-B

E911 ADDRESS 6440 GATEWAY BLVD., # E EL PASO, TX 79905

PROJECT TYPE

PROPOSED 56'-10" TOP OF STEEL & NOT TO EXCEED 64'-10" TOP OF BRANCHES

CONSULTING TEAM

MANAGEMENT PROFESSIONAL SIINO DESIGN, LLC 16616 EAST PALISADES BOULEVARD SUITE #102 FOUNTAIN HILLS, ARIZONA 85268
CONTACT: CHRISTOPHER M. SIINO, MS, PMP

PHONE: (480) 836-1701 FAX: (480) 836-1004 SURVEYING FIRM:

410 EAST SOUTHERN AVENUE

TEMPE, ARIZONA 85282 (480)659-4072 CONTACT: MATTHEW FORD PHONE: (602) 463-0472

ELECTRICAL ENGINEER: EE LLC CONTACT: LOREN PRIEST

MOBILE: (303) 748-1189

VICINITY MAP



PROJECT DESCRIPTION


INSTALLATION OF NEW 64'-10" TALL MONOPINE WITH ANTENNA ARRAYS & (2) NEW EQUIPMENT CABINETS WITHIN A 20'X30' CMU WALLED

SPECIAL INSPECTIONS REQUIRED

DRILLED CAISSON: CONCRETE REINFORCING: BOLTS IN CONCRETE: YES (CONTINUOL MASONRY CONSTRUCTION: YES (PERIODIC) STEEL CONSTRUCTION:

YES (CONTINUOUS) YES (CONTINUOUS) N/A

REGIONAL MAP

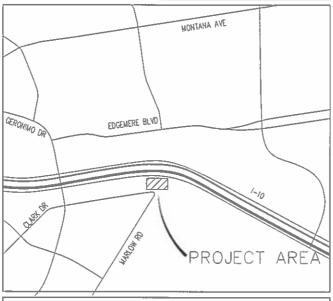

DRIVING DIRECTIONS

FROM LOCAL CITY OR NEAREST MAJOR HIGHWAY INTERSECTION:

FROM EL PASO INTERNATIONAL AIRPORT: TAKE AIRWAY BLVD. TOWARD GERONIMO DR. THEN TURN LEFT ONTO GATEWAY BLVD. E. ARRIVE AT

CODE COMPLIANCE

ALL WORK AND MATERIALS SHALL BE PERFORMED AND INSTALLED IN ACCORDANCE WITH THE CURRENT EDITIONS OF THE FOLLOWING CODES AS ADOPTED BY THE LOCAL GOVERNING AUTHORITIES. NOTHING IN THESE PLANS IS TO BE CONSTRUED TO PERMIT WORK NOT CONFORMING TO THESE CODES.

. 2012 INTERNATIONAL BUILDING CODE (IBC) 2011 NATIONAL ELECTRICAL CODE (NEC)

ANSI/EIA-222-G STRUCTURAL STANDARDS FOR ANTENNA SUPPORTING STRUCTURES & ANTENNAS

PROJECT INFORMATION

SITE NAME: ELP CLARK

APPLICANT:

OCCUPANCY

6440 GATEWAY BLVD., # E EL PASO, TX 79905 SITE ADDRESS:

JURISDICTION: CITY OF EL PASO

COUNTY: EL PASO ZONING: COMMERCIAL

PROPERTY OWNER: GREGG M. SELTZER & JULIE P. SELTZER TRUST

212 26TH STREET #127 SANTA MONICA, CA 90402

PHONE: (310) 230-6724

SBA TOWERS IX LLC, A DELAWARE L.L.C. 8051 CONGRESS AVENUE

BOCA RATON, FL 33487 PHONE: 1-800-487-7483

CONTACT: CASEY SPIEGEL PHONE: (318) 218-8192

SITE COORDINATES: 2C/1A

31° 46′ 53.2″ N 106° 24′ 06.6″ W ±3,858.3′ (AMSL) LATITUDE: (NAD 83) LONGITUDE: (NAD 83) (NAVD 88) UNMANNED

CONSTRUCTION TYPE: RAW LAND

ACCESS DISCLAIMER

THE NEW PROJECT IS AN UNOCCUPIED TELECOM FACILITY AND IS NOT TO BE ACCESSED BY THE GENERAL PUBLIC. THIS FACILITY IS EXEMPT FROM DISABLED ACCESS REQUIREMENTS PER IBC 1103.2 9 LISTED AS AN EQUIPMENT SPACE.

BLUE STAKE!

Two working days before you dig, CALL FOR THE BLUE STAKE!

1 (602) 263-1100 or 1 (800) STAKE-IT (782-5348) (OUTSIDE MARICOPA COUNTY)

SHEET INDEX

CITY DEVELOPMENT DEPARTMENT PLANNING DIVISION DETAILED SITE DEVELOPMENT PLAN APPROVED BY THE CITY COUNCIL

SBA TOWERS IN LLC

APPLICANT

EXCECUTIVE SECRETARY CITY PLAN COMMISSION

CITY MANAGER

9.W

	OTTLET HIDEK
NO.	DESCRIPTION
T-1	TITLE SHEET
T-2	ABBREVIATIONS & SYMBOLS
C-1.0	SETBACK PLAN (COLOR)
C-1.1	SETBACK PLAN (NON-COLOR)
C-1.2	SETBACK PLAN
C-1.3	PARKING CALCULATIONS
C-1.4	OVERALL SITE PLAN & LEGAL DESCRIPTIONS
C-2	SITE GRADING PLAN
C-3	ENLARGED SITE PLAN
C-4	ANTENNA CONFIGURATION
C-5	ELEVATION
C-6	CONSTRUCTION DETAILS
C-7	CONSTRUCTION DETAILS
C-8	CONSTRUCTION DETAILS
E-1	UTILITY SITE PLAN
E-2	ENLARGED POWER PLAN
E-3	UTILITY DETAILS
E-4	SINGLE-LINE DIAGRAM & PANEL SCHEDULE
EG-1	GROUNDING PLAN & NOTES
EG-2	GROUNDING DETAILS
GN-1	GENERAL NOTES
LS-1	SITÉ SURVEY
LS-2	SITE SURVEY

UTILITY CONTACT INFORMATION

POWER_COMPANY: EL PASO ELECTRIC CO.

TELEPHONE COMPANY TBD

⋖ \mathbf{m} S

SBA TOWE A DELAWARE L. 5900 BROKEN S. BOCA RATON PHONE: 1-87

ast PALISADES BLVD UNIT # 102 HILLS, ARIZONA 852, (480) 836–1701 (480) 836–1704 ..siinodesign.com esign 16616 EAST F UNIT DUNTAIN HILLS

PE SEAL:

SiinoDe



(로 B 이 O O U L O

SITE I.D TX17739-B

SITE NAME:

ELP CLARK

SITE ADDRESS: 6440 GATEWAY BLVD., # E EL PASO, TX 79905

DRAWN BY: JN CHECKED BY YJ DATE: 8/2/16 PROJECT #: TBD

SHEET TITLE:

TITLE SHEET

SHEET NO.

T-1


ABBREVIATIONS

AB	ANCHOR BOLT	GR	GRADE
AC	ASPHALTIC CONCRETE	GYP	GYPSUM
A/C	AIR CONDITIONING	GFCI	GROUND FAULT CIRCUIT
ADJ	ADJUSTABLE	0. 0.	INTERRUPT
A.F.F.	ABOVE FINISH FLOOR	GND	GROUND
ARCH	ARCHITECTURAL	HC	HOLLOW CORE
		HDW	
APPROX	APPROXIMATELY		HARDWARE
A.G.L.	ABOVE GRADE LEVEL	HTR	HEATER
A.M.S.L.	ABOVE MEAN SEA LEVEL	HM	HOLLOW METAL
BD	BOARD	HORIZ	HORIZONTAL
BLDG	BUILDING	HR	HOUR
BLKG	BLOCKING	HT	HEIGHT
BOT	ВОТТОМ	HV	HIGH VOLTAGE
BSMT	BASEMENT	ID	INSIDE DIMENSION
BTS	BASE TRANSCEIVER	INS	INSULATION
	STATION	INT	INTERIOR
С	COURSE(S)	JT	JOINT
CEM	CEMENT	LAM	LAMINATED
CL	CHAIN LINK	LBS	POUNDS
CLG	CEILING	LT	LIGHT
CLR	CLEAR	LA	LIGHTNING ARRESTOR
COL	COLUMN	LNA	LOW NOISE AMPLIFIER
CONC	CONCRETE	MFR	MANUFACTURER
CONST	CONSTRUCTION	MAT	MATERIAL
CONT	CONTINUOUS	MAX	MAXIMUM
CORR	CORRIDOR	MECH	MECHANICAL
		MIN	MINIMUM
CO	CONDUIT ONLY		Approx
DIA	DIAMETER	MISC	MISCELLANEOUS
DBL	DOUBLE	MŁ	METAL LATH
DEPT	DEPARTMENT	МО	MASONRY OPENING
DEMO	DEMOLITION	MS	MACHINE SCREW
DIM	DIMENSION	MTD	MOUNTED
ÐΝ	DOWN	MTL	METAL
ÐR	DOOR	(N)	NEW
DTL	DETAIL	NIC	NOT IN CONTRACT
DWG	DRAWING	NO	NUMBER
(E)	EXISTING	NTS	NOT TO SCALE
ΕA	EACH	0	OVERHEAD
ELEC	ELECTRIC	OA	OVERALL
ELEV	ELEVATION	0.C.	ON CENTER
EQUIP	EQUIPMENT	OPNG	OPENING
EXP	EXPANSION	OPP	OPPOSITE
EXT	EXTERIOR	PARTN	PARTITION
FA	FIRE ALARM	PL	PLATE
FB	FLAT BAR	PLAS	PLASTER
FF	FINISH FLOOR	PLYWD	PLYWOOD
FH	FLAT HEAD	POC	POINT OF CONNECTION
FIN	FINISH(ED)	PROP	PROPERTY
		PT	PRESSURE TREATED
FLR	FLOOR		
FOS	FACE OF STUDS	R	RISER
FS	FINISH SURFACE	REQD	REQUIRED
FT	FOOT, FEET	RD	ROOF DRAIN
FTG	FOOTING	RM	ROOM
FW	FINISH WALL	RMS	ROOMS
F.G.	FINISH GRADE	RO	ROUGH OPENING
FUT	FUTURE	SC	SOLID CORE
GA	GAUGE	SCHED	SCHEDULE
GALV	GALVANIZED	SECT	SECTION
GL	GLASS	SHT	SHEET

SIM	SIMILAR
SPECS	SPECIFICATIONS
SS	STAINLESS STEEL
STL	STEEL
STOR	STORAGE
STRUCT	STRUCTURAL
SUSP	SUSPENDED
SW	SWITCH
SWBO	SWITCHBOARD
THK	THICK
Tì	TENANT IMPROVEMENT
TMA	TOWER MOUNTED AMPLIFIE
TOS	TOP OF SURFACE
TS	TUBE STEEL
TYP	TYPICAL
U	UNDERGROUND
UNO	UNLESS NOTED
	OTHERWISE
VCT	VINYL
	COMPOSITION
	TILE
VERT	VERTICAL
V.I.F.	VERIFY IN FIELD
VG	VERTICAL GRAIN
W/	WITH
WD	WOOD
WR	WATER RESISTANT
WT	WEIGHT
XFMR	TRANSFORMER
0	AT
	CHANNEL
<u>e</u>	CENTERLINE
4	ANGLE

PROPERTY LINE




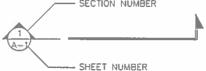


BUILDING SECTION REFERENCE



DETAIL REFERENCE

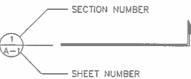

DETAIL SECTION REFERENCE

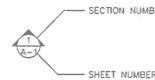

ELEVATION VIEW REFERENCE







WORK POINT



#\ REVISION OR CONTROL POINT





ELEVATION REFERENCE

SYMBOLS:

SECTION NUMBER	N
SHEET NUMBER	



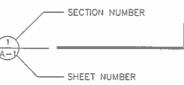

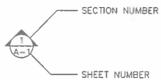



(101) DOOR NUMBER

101 AREA AND/OR ROOM NUMBER



UTILITY POLE





	MASONRY
	BRICK
A STATE OF THE PARTY	CONCRETE
	EARTH
	STEEL

GRAVEL CENTER LINE PROPERTY LINE

LEASE LINE EASEMENT LINE RIGHT-OF-WAY CHAIN LINK FENCE

WOOD FENCE SILT FENCE

BELOW GRADE ELECTRIC BELOW GRADE TELEPHONE ----UT----

----UE----

OVERHEAD ELECTRIC/TELEPHONE -OH-

OVERHEAD TELEPHONE OVERHEAD ELECTRIC -UE-CONTOUR -276-

TREE PROTECTION FENCE

TREE LINE

SANITARY SEWER LINE WATER LINE

TREES, SHRUBS, BUSHES

NATURAL GAS LINE WATER FLOW DIRECTION



SiinoDesign

4 SB

딤



DESCRIPTION	REVIEW	FIXAL	REMOVED GENERATOR	CITY COMMENTS	CITY COUMENTS	CITY COMMENTS	CITY COMMENTS	CITY COMMENTS
DATE	02/10/16	07/12/16	08/02/16	10/14/16	01/23/17	02/28/17	21/11/10	04/20/17
NO.	A	8	ပ	۵	L	Ŀ	Ö	I

SITE I.D.: TX17739-B

SITE NAME: ELP CLARK

SITE ADDRESS: 6440 GATEWAY BLVD., # E EL PASO, TX 79905

DRAWN BY: JN CHECKED BY: LY DATE: 8/2/16

SHEET TITLE:

TBD


PROJECT #:


ABBREVIATIONS & SYMBOLS


SHEET NO.


T-2




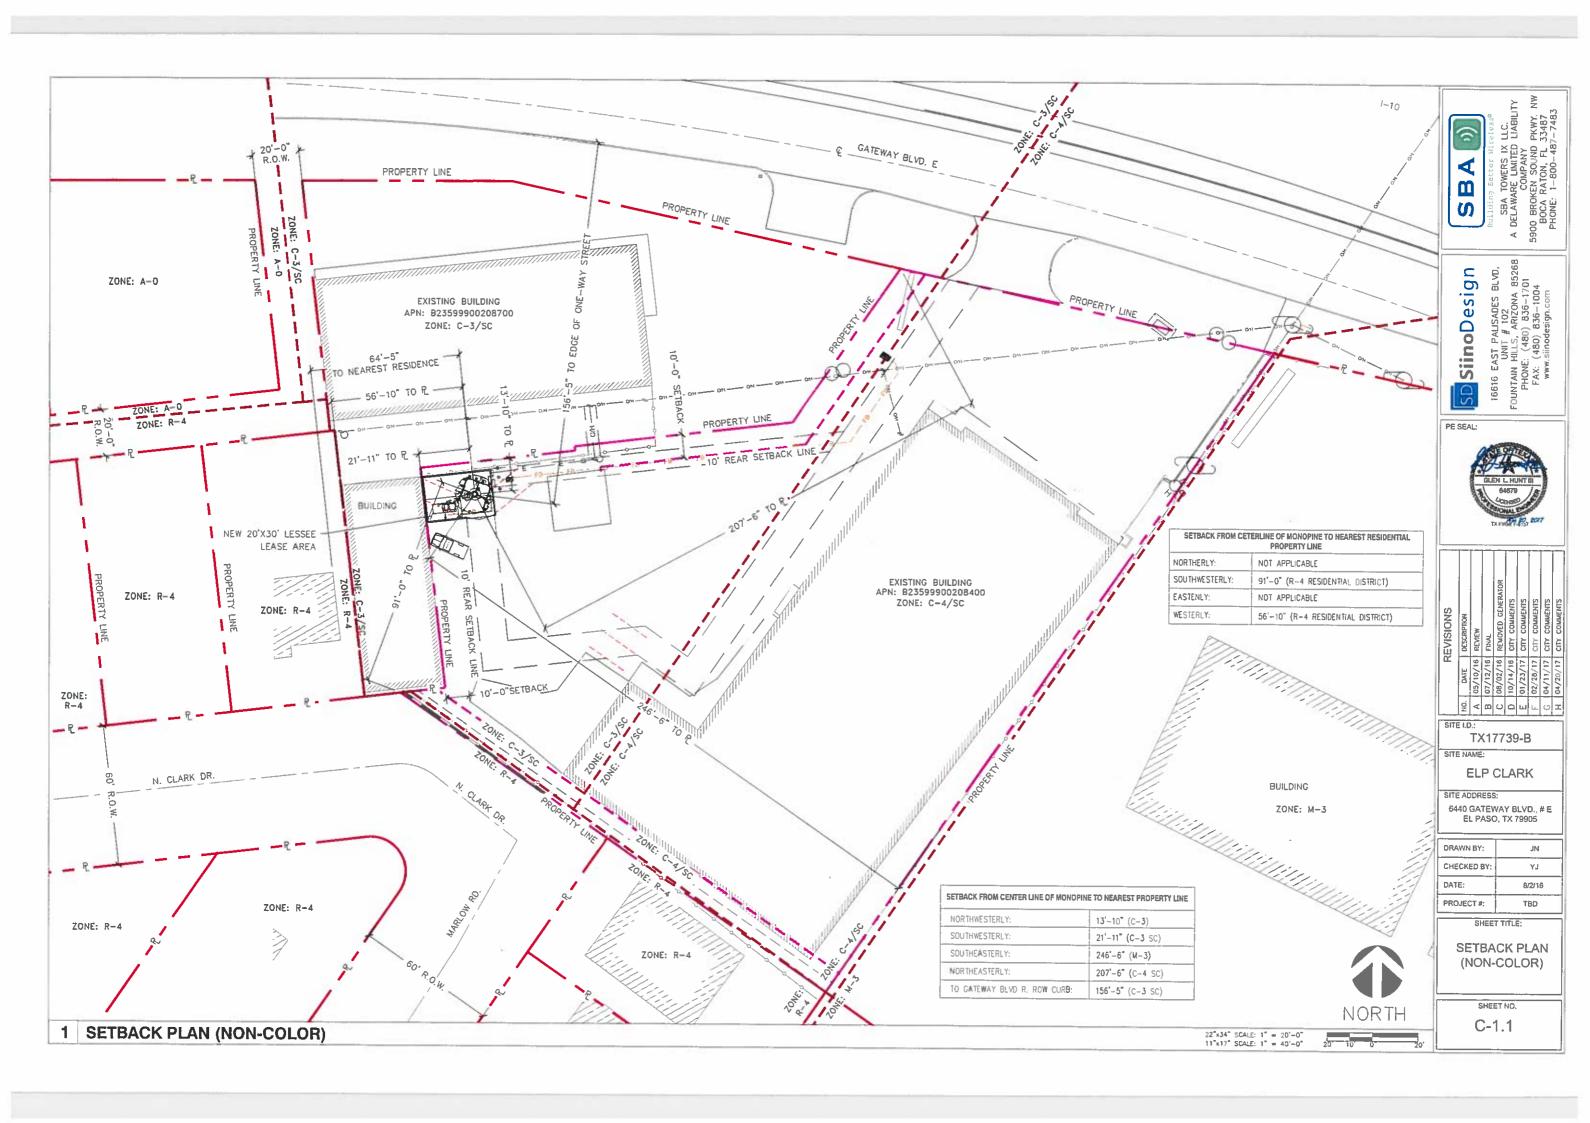


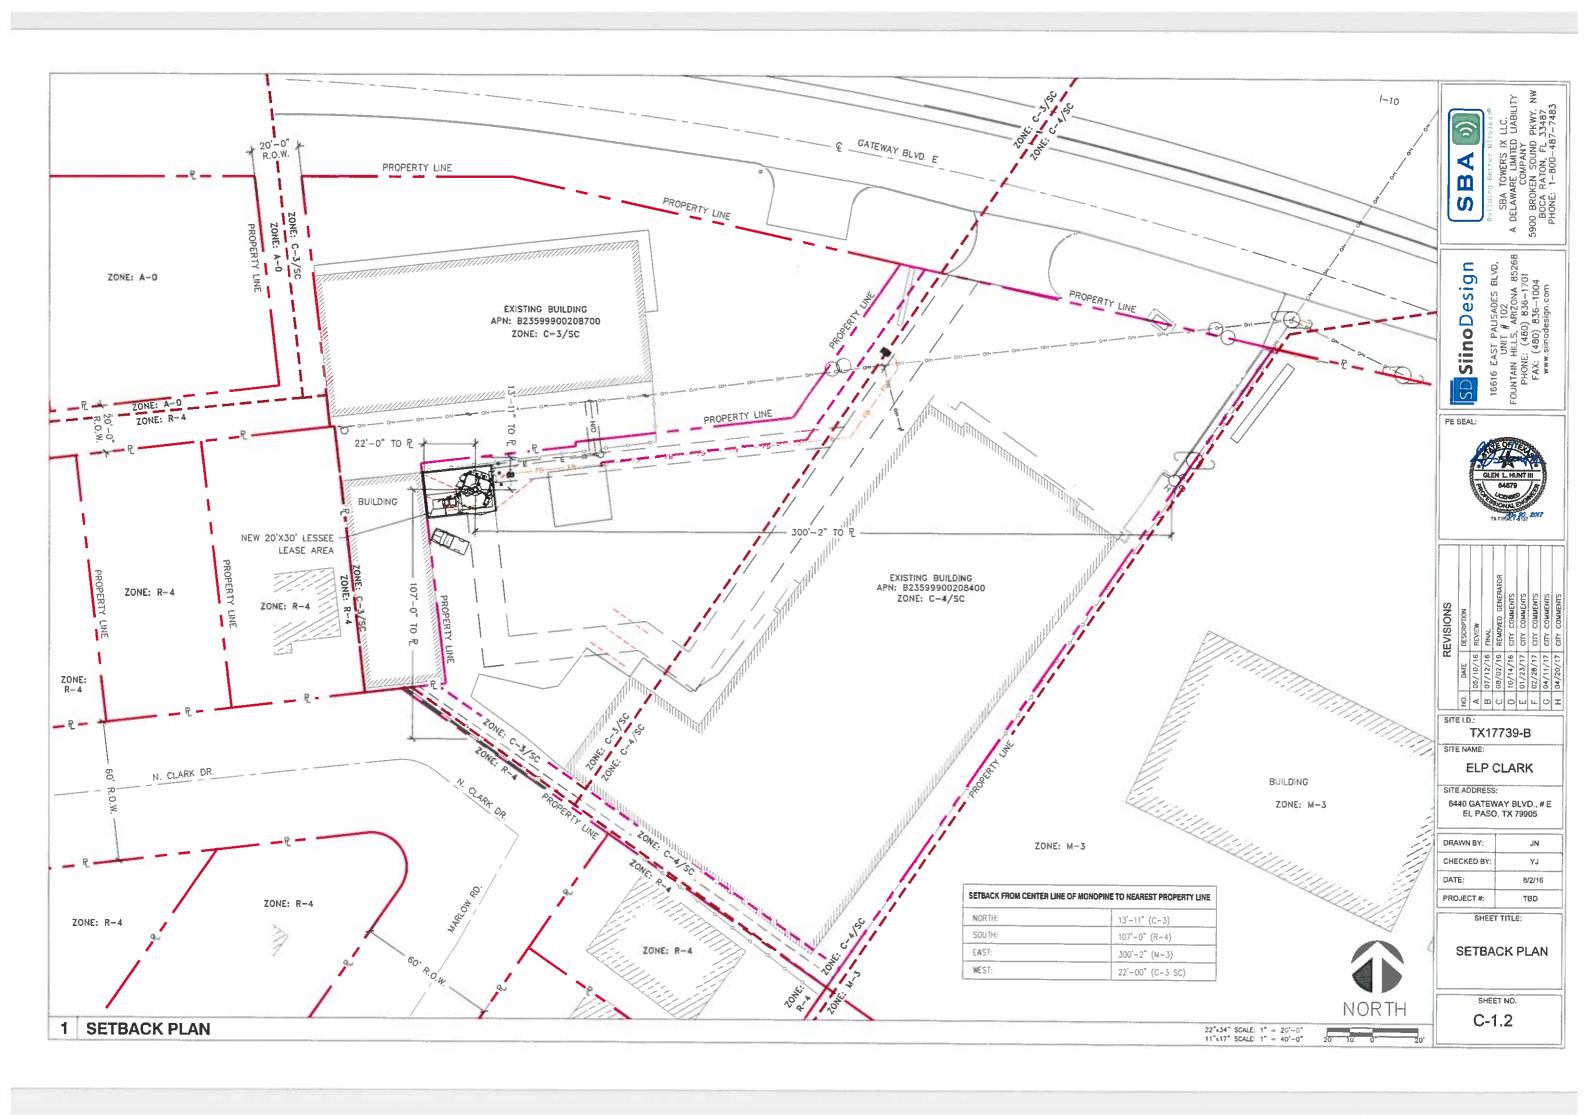


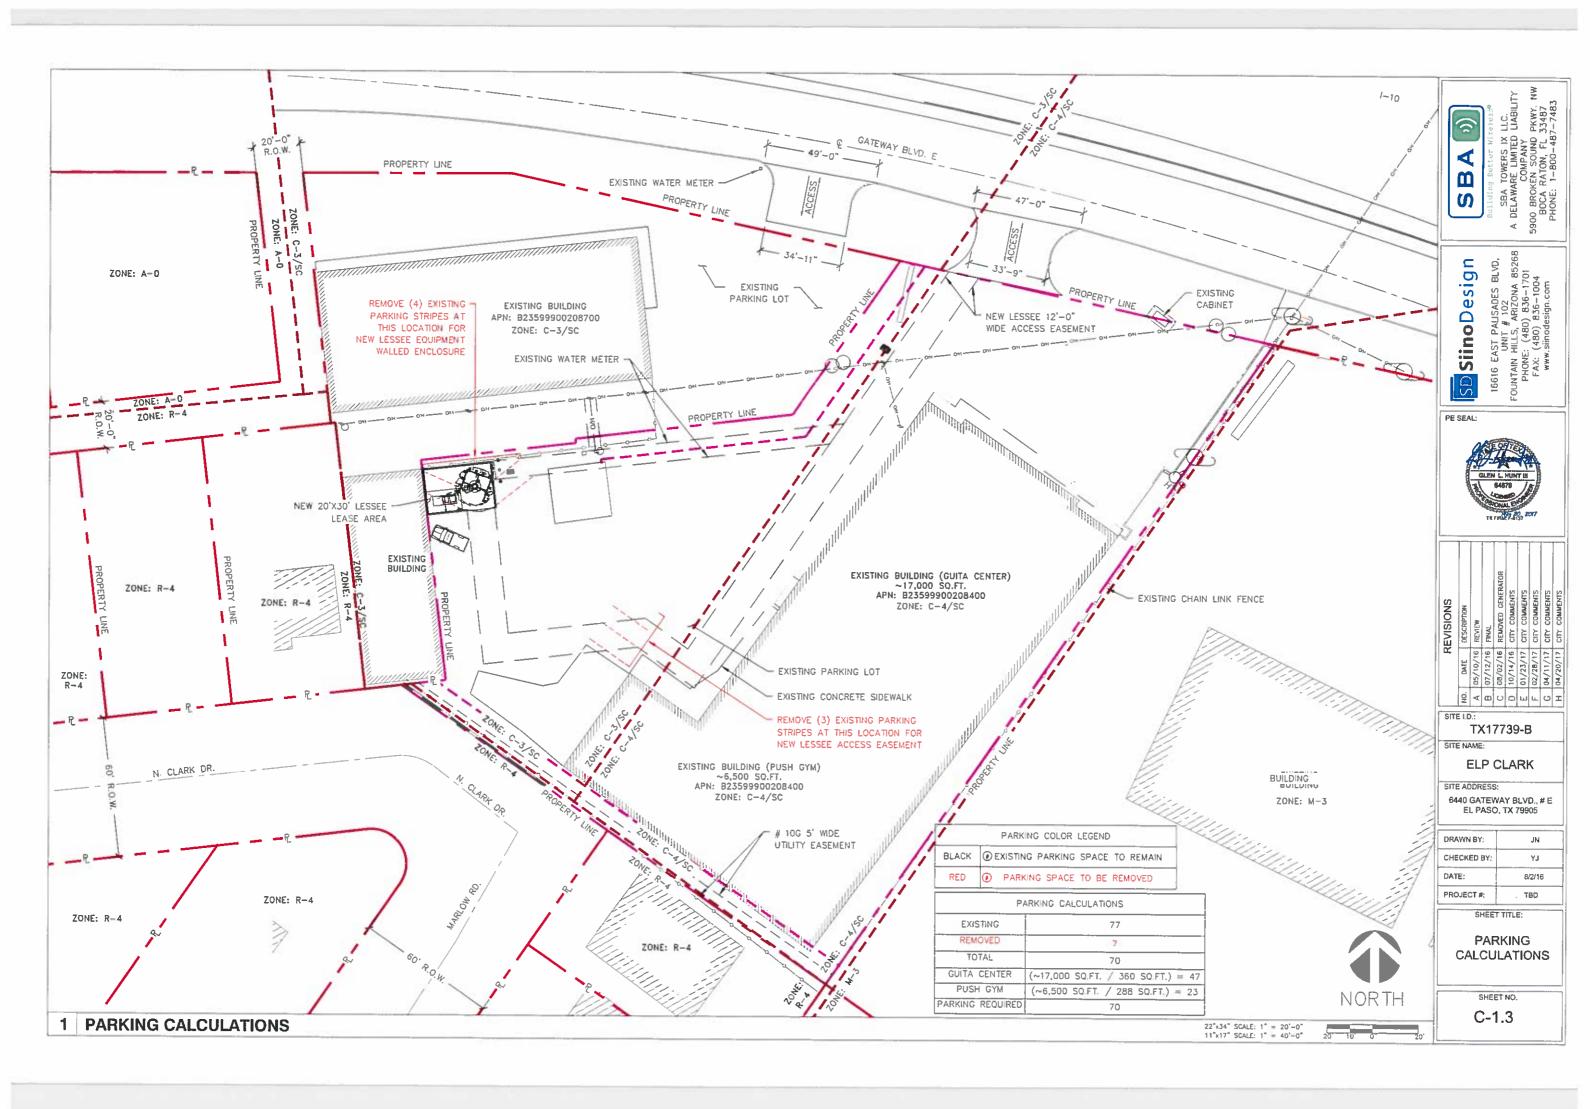

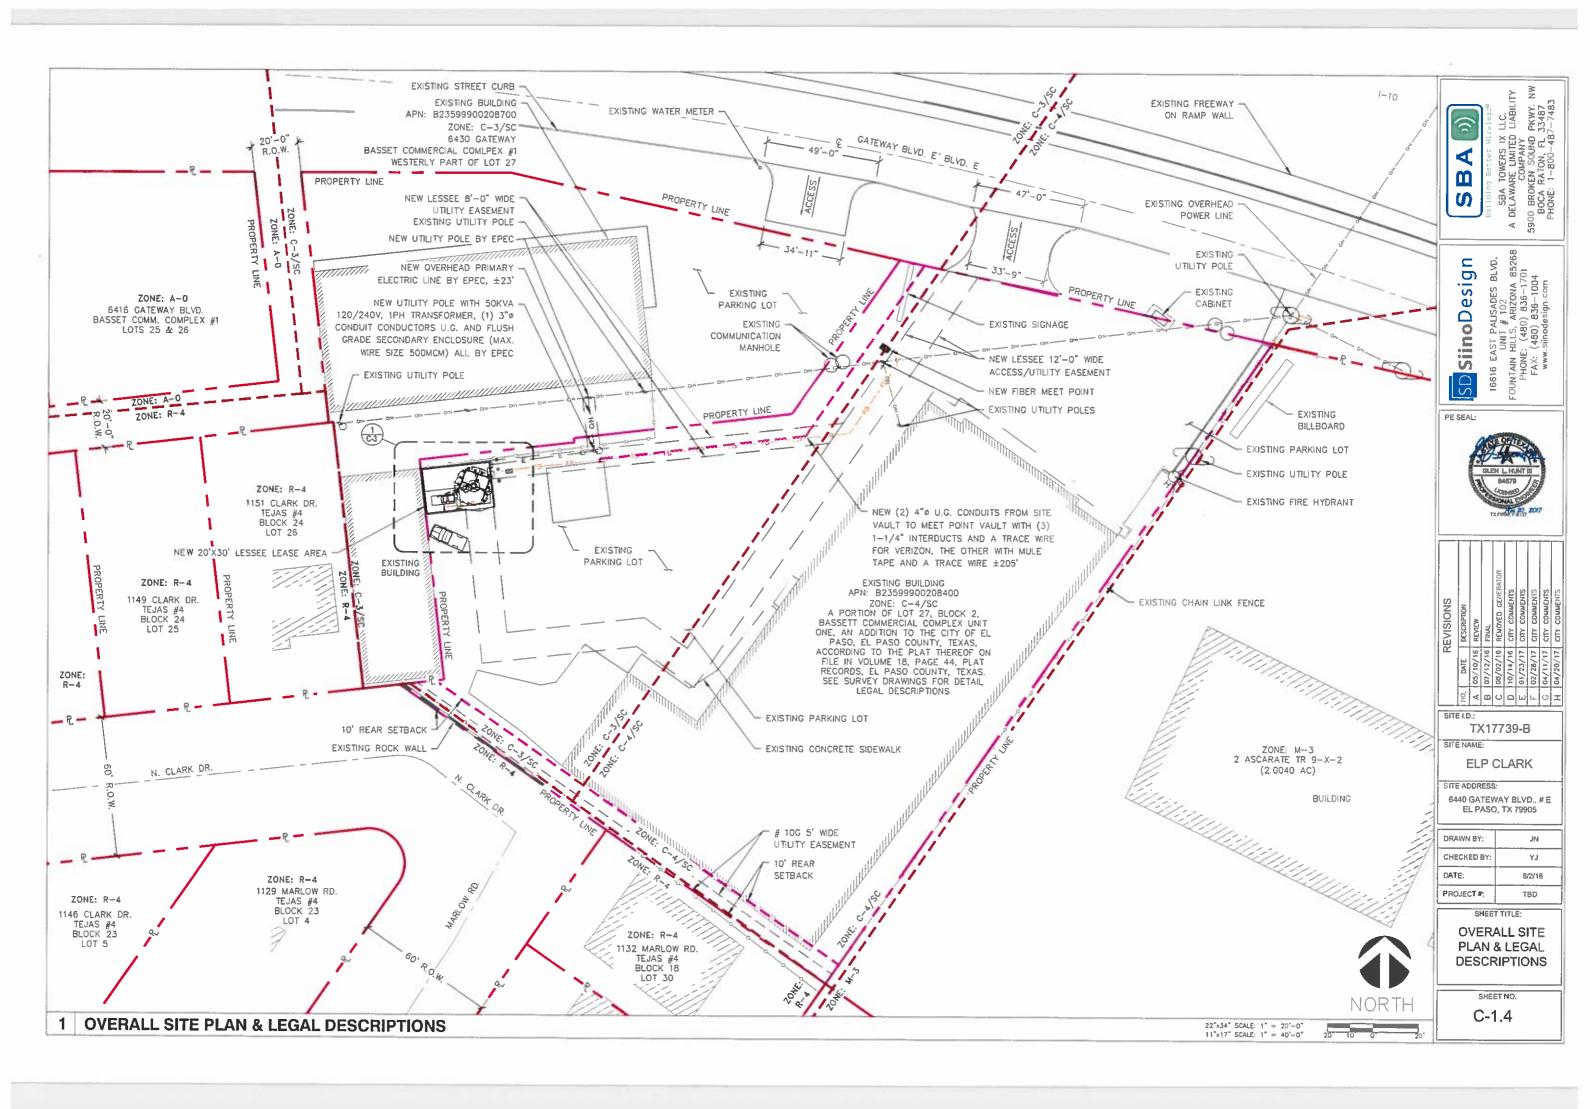

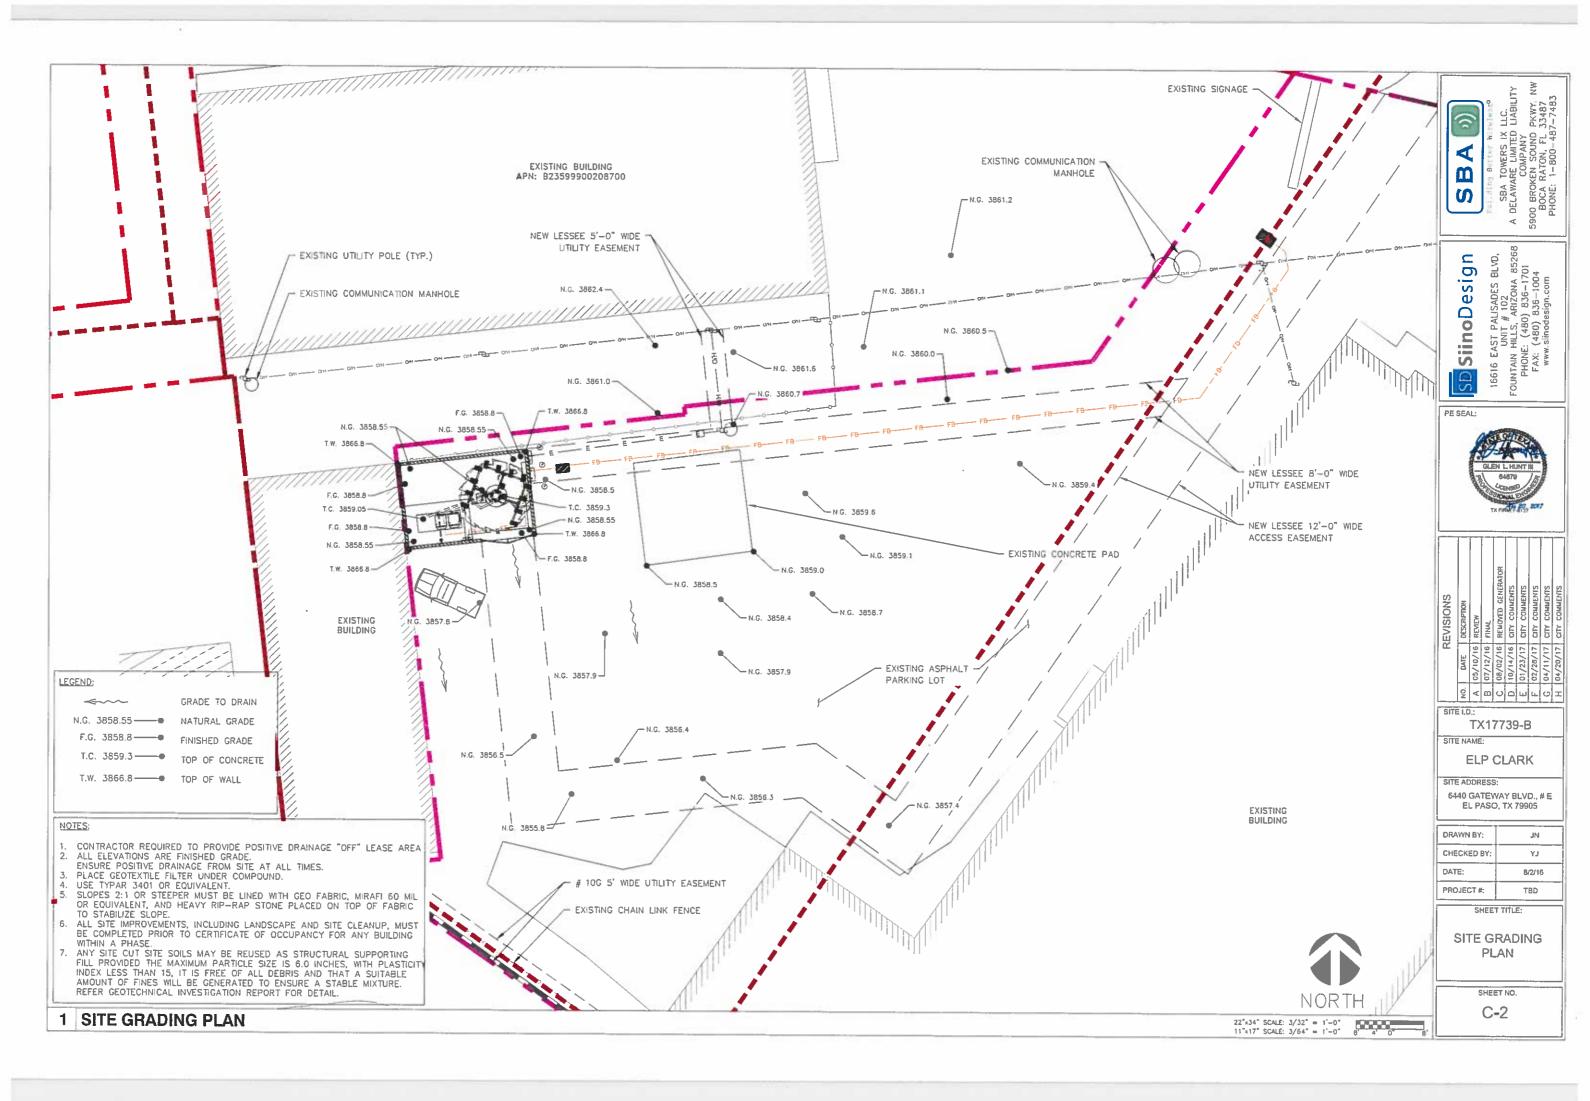


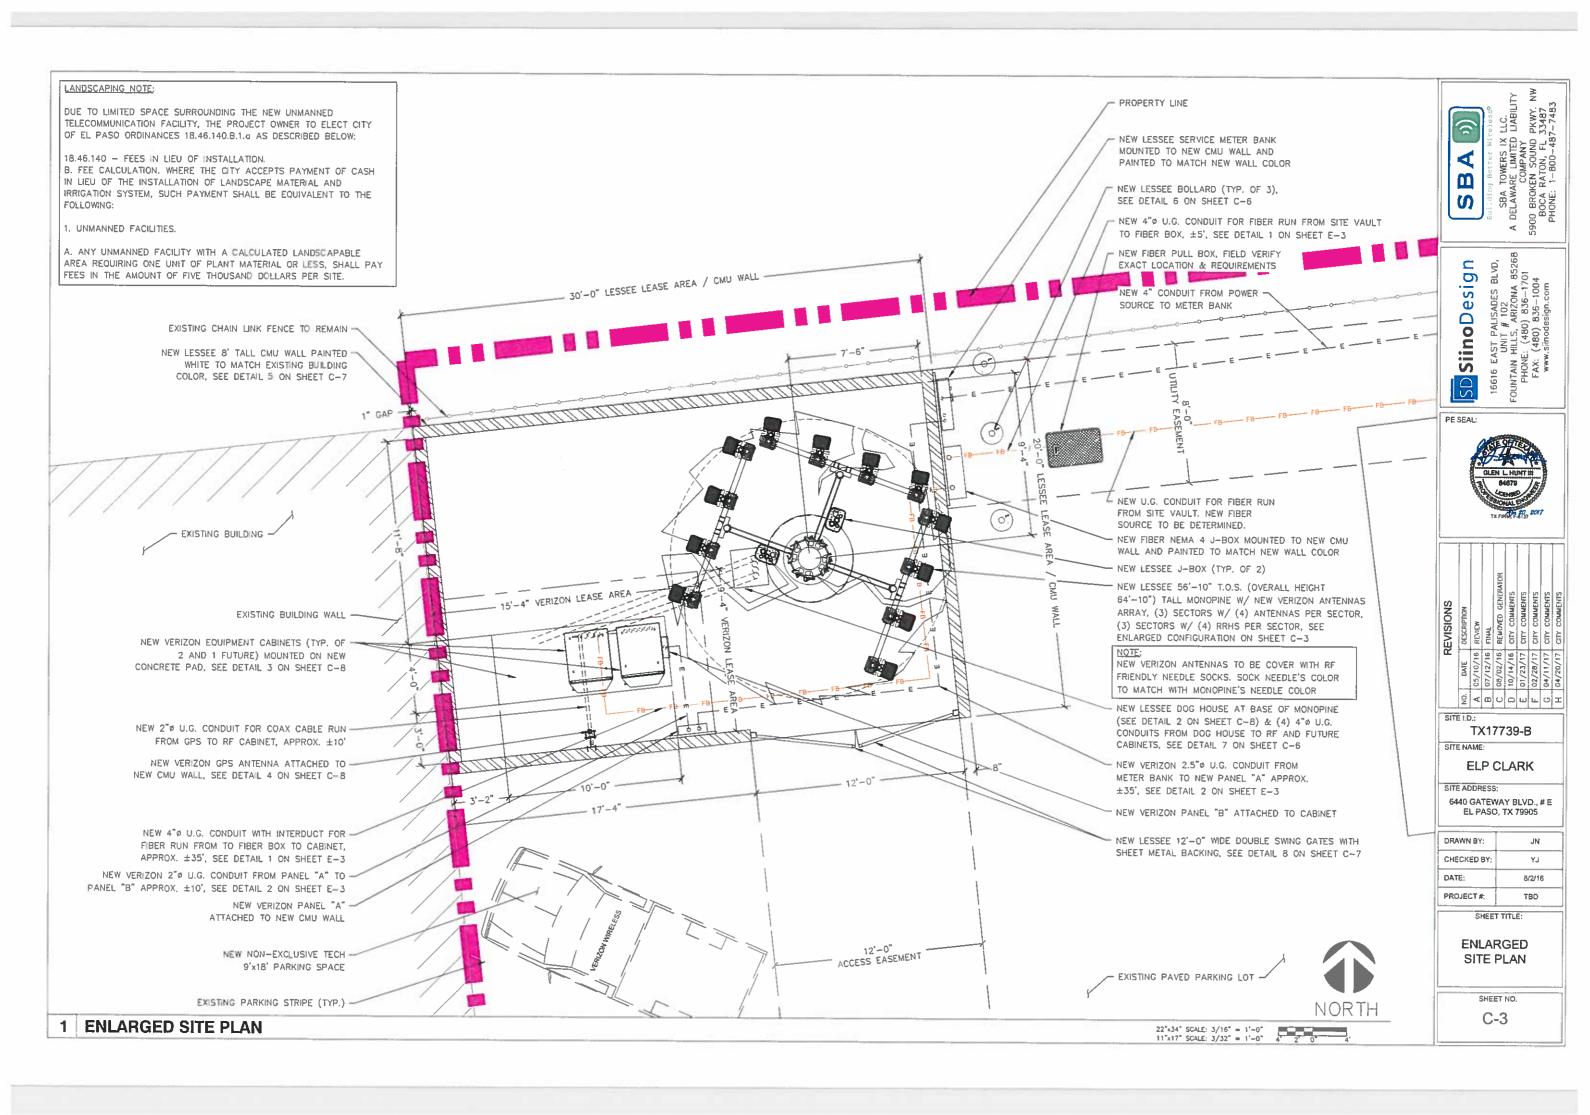


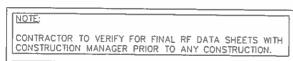

			NEV	V ANTENNA	A & HYBRI	D DC	/FIBER	TABLE
SECTOR	ANT. POSITION NO.	QTY.	RRH QTY.	AZIMUTH	DOWNTILT	و (FT)	# OF LINE	COAX TYPE
ALPHA	1 (700)	1	1	10°	4*	50	0	N/A
ALPHA	2 (AWS)	1	1	10"	4°	50	0	N/A
ALPHA	3 (850)	1	1	10"	4.	50	1	RSS 6-12 HYBRID DC/FIBER
ALPHA	4 (PCS)	1	1	10°	4*	50	1	RSS 6-12 HYBRID DC/FIBER
BETA	1 (700)	1	1	110°	4.	50	0	N/A
BETA	2 (AWS)	1	1	110"	4.	50	0	N/A
BETA	3 (850)	1	1	110	4*	50	0	N/A
BETA	4 (PCS)	1	1	110*	4*	50	0	N/A
GAMMA	1 (700)	1	1	270°	4"	50	0	N/A
GAMMA	2 (AWS)	1	1	270"	4°	50	0	N/A
GAMMA	3 (850)	1	1	270*	4°	50	0	N/A
GAMMA	4 (PCS)	1	1	270°	4*	50	0	N/A

- 1. JUNCTION BOXES: ADD (2) JUNCTION BOXES ON TOP & (2) JUNCTION BOXES AT THE BOTTOM TOWER, OR WHATEVER IS NEEDED TO DEPLOY (12) RRHs.
- 2. DC/FIBER: ADD (3) RUNS OF RSS 6-12 HYBRID CABLE (6-12 DC/FIBER BUNDLE) TO CONNECT J-BOXES.
- 3. SEE DETAIL #5 FOR RRHS LOCATIONS AND SPECIFICATIONS.

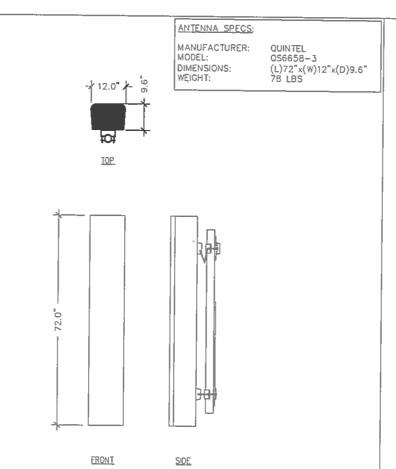

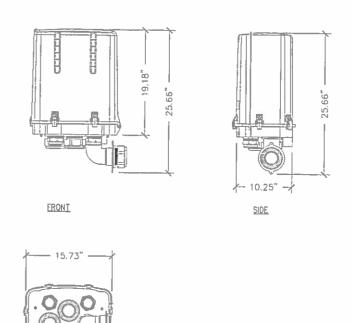



1 COAXIAL CABLE TABLE

NOTES:

1. THE STRUCTURAL ANALYSIS AND I

OTHERS.

2. VERIZON ANTENNAS TO BE COVER WITH RF FRIENDLY NEEDLE SOCKS

DESIGN OF NEW MONOPINE AND ITS FOUNDATION IS PROVIDED BY

2 NEW ANTENNA DETAIL SCALE: N.T.S.

ANTENNA MOUNTING PIPE UNLESS FIELD CONDITIONS WARRANT USE

OF NEW VERTICAL MOUNTING PIPE

NEW LESSEE REMOTE

RADIO HEAD (RRH)

WIDTH

12"

11.8"

12"

RRH SPECIFICATIONS

DEPTH

7.2"

9"

7.2"

HEIGHT W/O CABLE

MANAGEMENT COVER

21.6

25.8"

21.6"

21.2"

NOTE; CONTRACTOR TO UTILIZE

3 NEW J-BOX SCALE: N.T.S.

MANUFACTURER SUPPLIED MOUNTING BRACKET

MOUNTING PIPE (SEE NOTE)

WEIGHT

W/O BRACKET

57.2 LBS. (W/O

MOUNTING BRACKET)

56.8 LBS. (W/O

MOUNTING BRACKET

57.2 LBS. (W/O

MOUNTING BRACKET

53 LBS. (W/O MOUNTING BRACKET)

BOTTOM

(ATTHOROGODODODO

SCALE: N.T.S.

— 12" — 	 	<u></u> 11.8" →
GOVORSSIERADADIQUE GOVORSSIERADA	FOUNDATION OF THE PROPERTY OF	CONTRIBOTO PUEDO DE CONTRIBO D

RRH (PCS)	RRH (700/850)	RRH (AWS)

(TYP. OF 2) NEW RING MOUNT BY MANUFACTURER SPECS NEW VERIZON (4) RRHs PER SECTORS TOTAL (12) RRHs, SEE DETAIL

NEW LESSEE MONOPINE

NEW VERIZON J-BOX

5 ON THIS SHEET NEW MOUNTING KIT, TYP. (3) SECTORS BY MANUFACTURER SPECS

> NEW VERIZON ANTENNAS (3) SECTORS WITH (4) ANTENNAS PER SECTOR, SEE NOTES

> > SCALE: N.T.S.

RRH (PCS) 12" RRH_NOTE; DIMENSIONS INCLUDE MOUNTING BRACKET, SOLAR SHIELD AND CONNECTORS.

RRH

RRH (700) 2X60

RRH (AWS)

2X90

RRH (850)

2X60

SCALE: N.T.S.

SHEET NO.

4 NEW ANTENNA CONFIGURATION

5 RRH DETAIL

POSITION

6 RRH DETAILS

FRONT

SITE I.D.: SITE NAME:

TX17739-B

ELP CLARK

6440 GATEWAY BLVD., # E EL PASO, TX 79905


DRAWN BY:	JN
CHECKED BY:	ΥJ
DATE:	B/2/16
PROJECT#:	TBD


ANTENNA


CONFIGURATION

SHEET TITLE

C-4

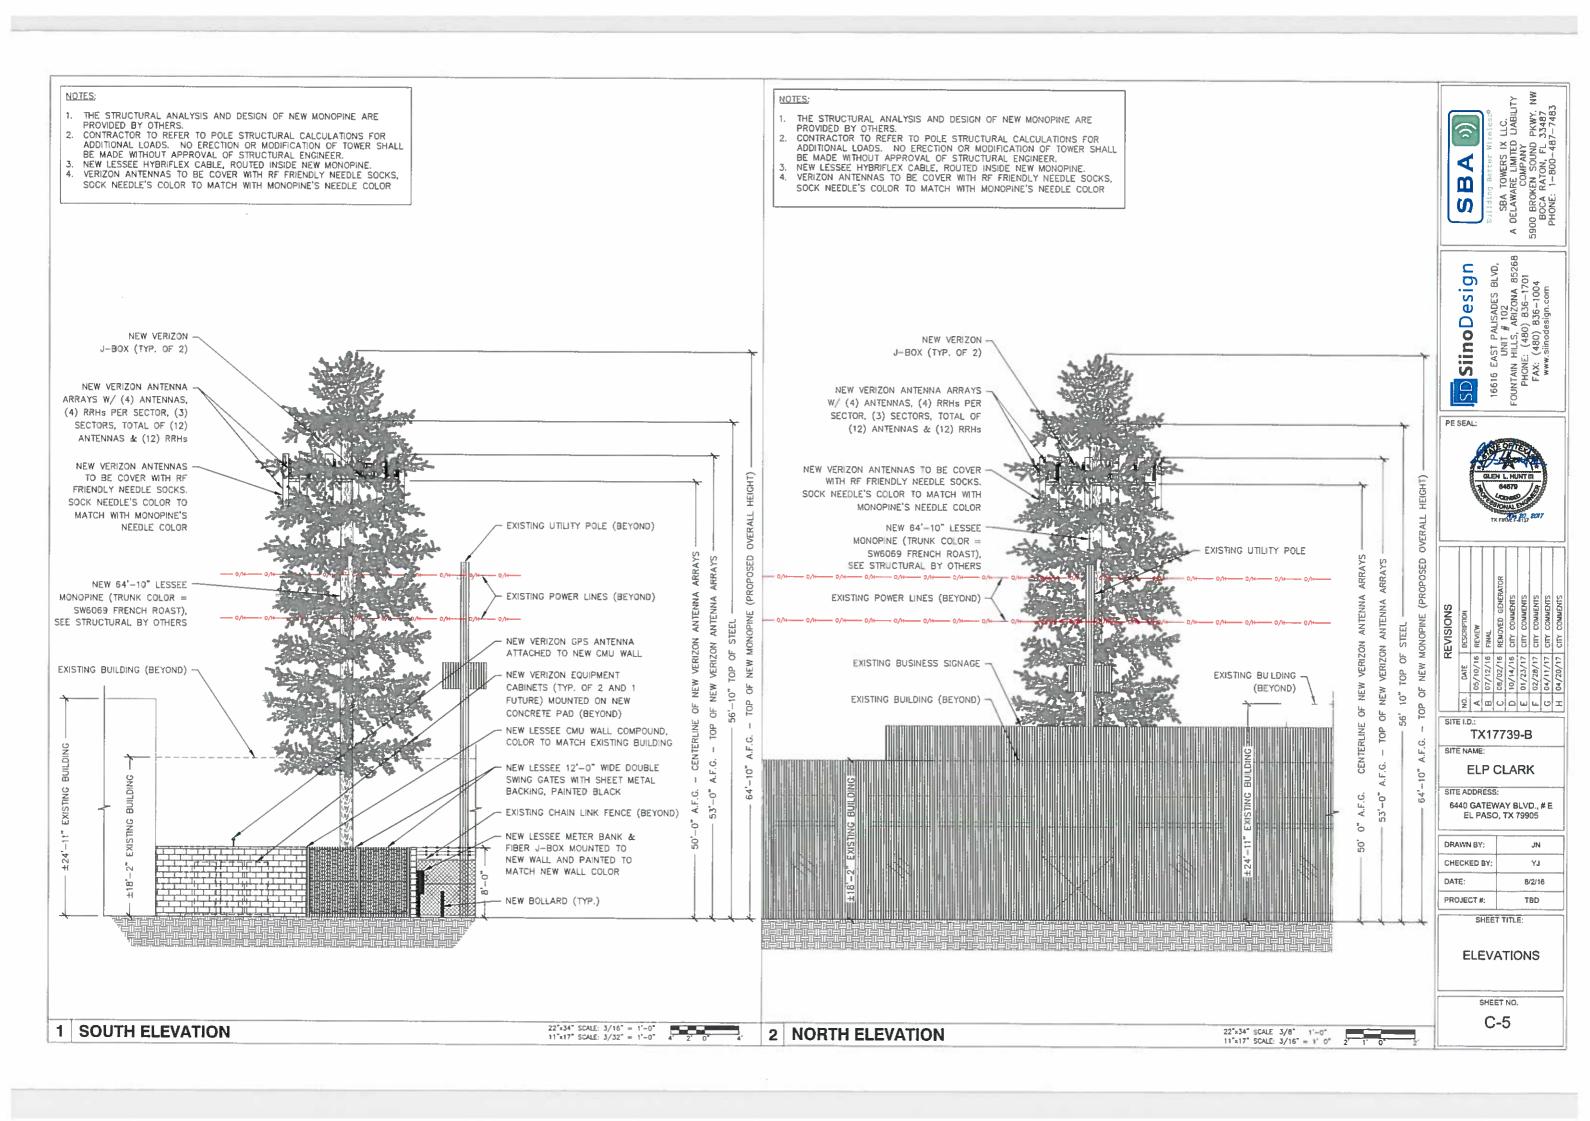

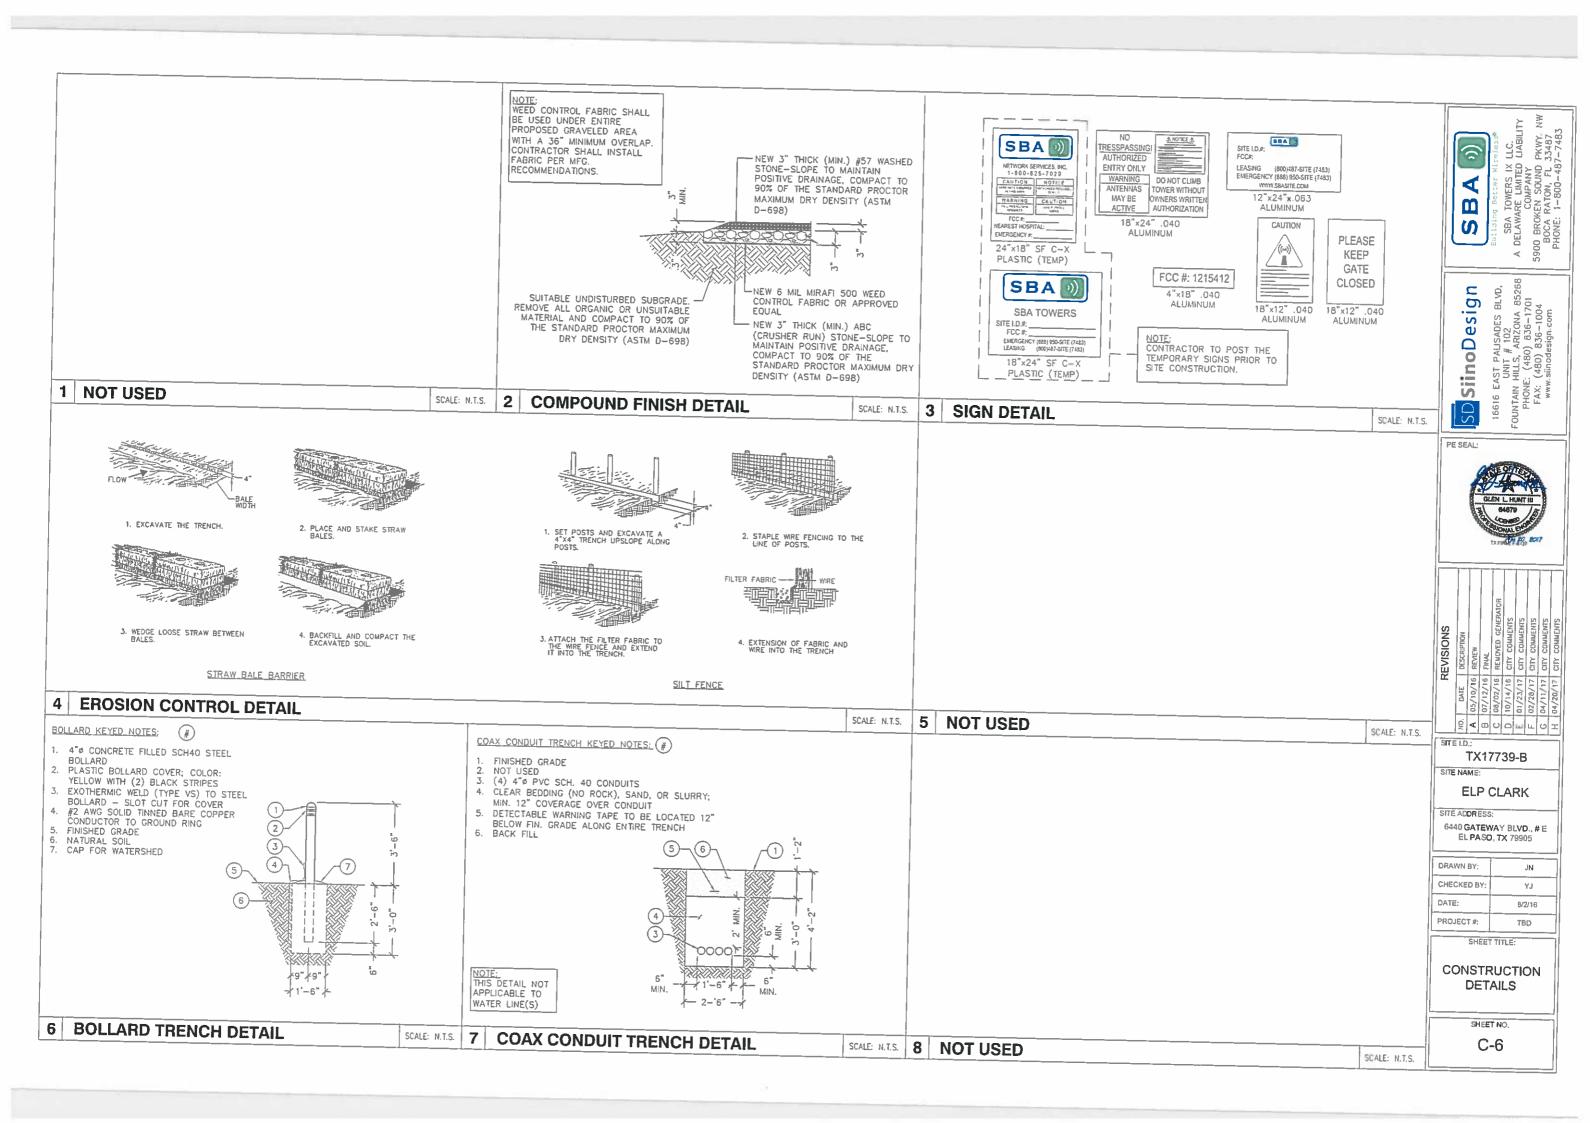

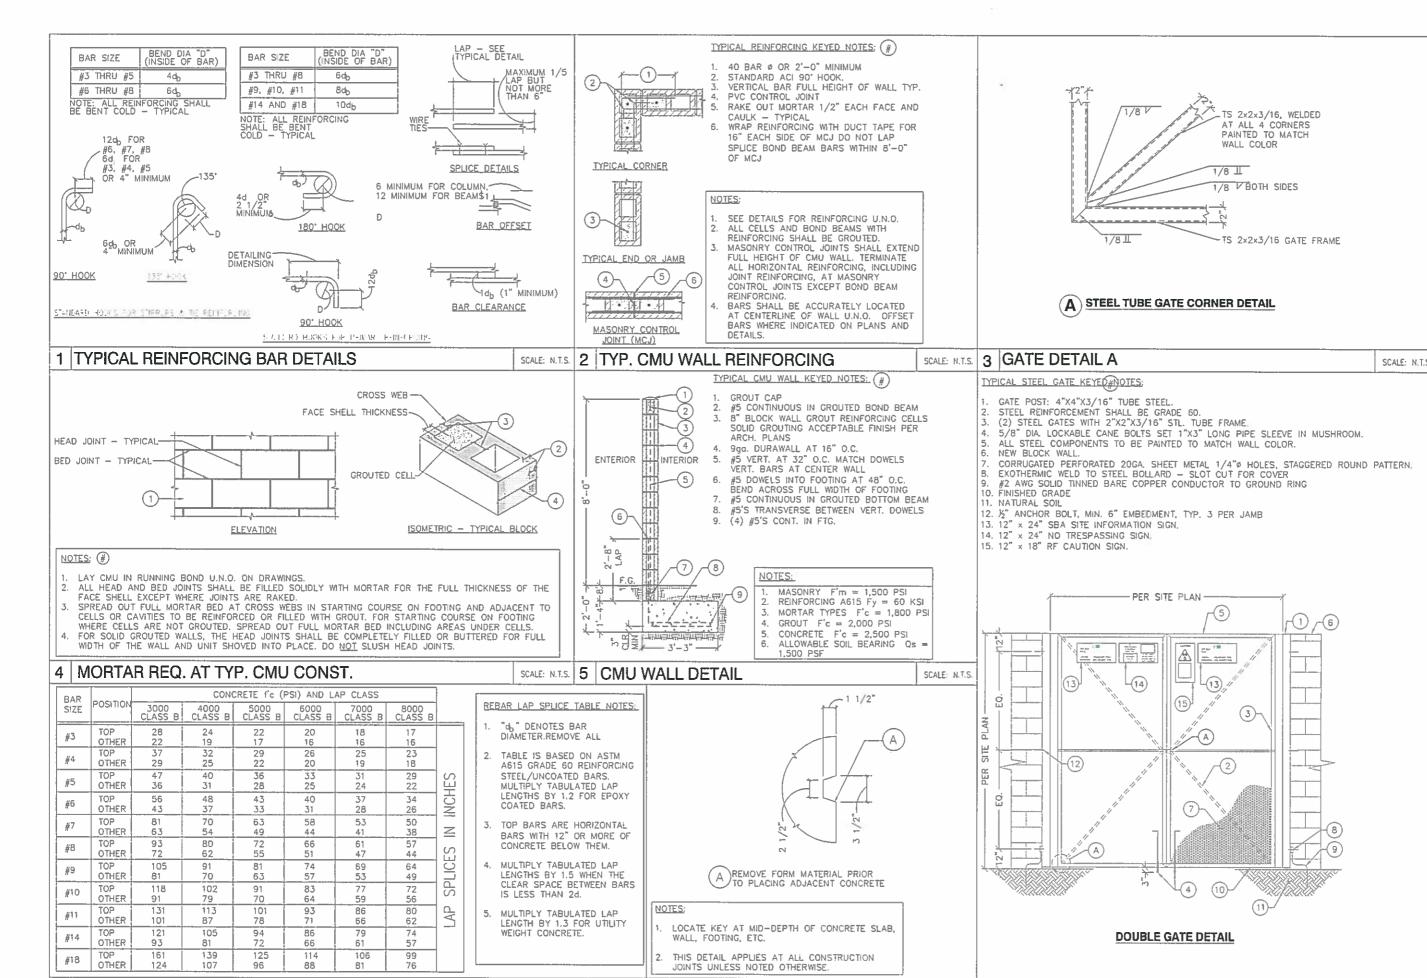

LLC. LIABILITY ⋖ m S

▽원→임단⁴ SBA DELAWAR 5900 BROK BOCA F PHONE:

핌 EAST UNI N HILL 16616 FOUNTAIN HIS PHONE: FAX: /

9

esi

Siino

PE SEAL:

SIABOURIO SITE I.D TX17739-B

SITE NAME: ELP CLARK

SITE ADDRESS

6440 GATEWAY BLVD., # E EL PASO, TX 79905

DRAWN BY: JN CHECKED BY YJ DATE: 8/2/16 PROJECT #: TBD

SHEET TITLE

CONSTRUCTION **DETAILS**


> SHEET NO. C-7


7 TYP. KEY IN CONC.


6 | REINFORCING BAR LAP SPLICE TABLE

SCALE: N.T.S. 8 GATE DETAIL

SCALE: N.T.S

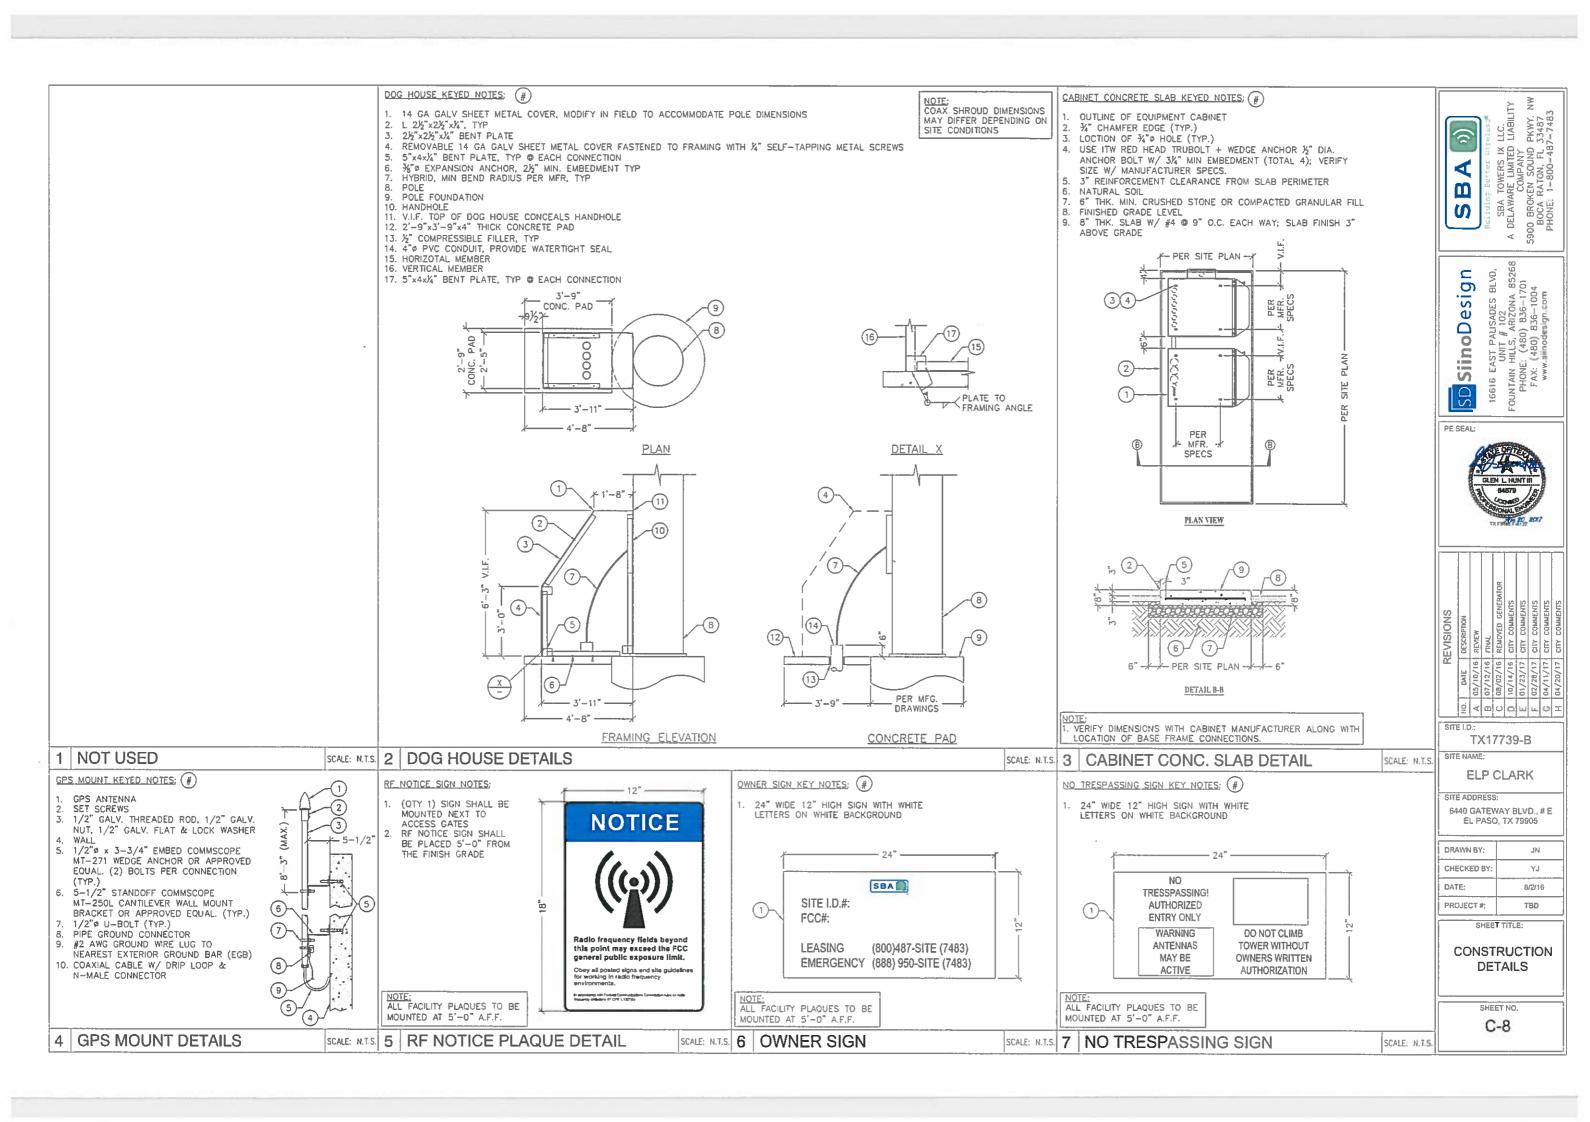

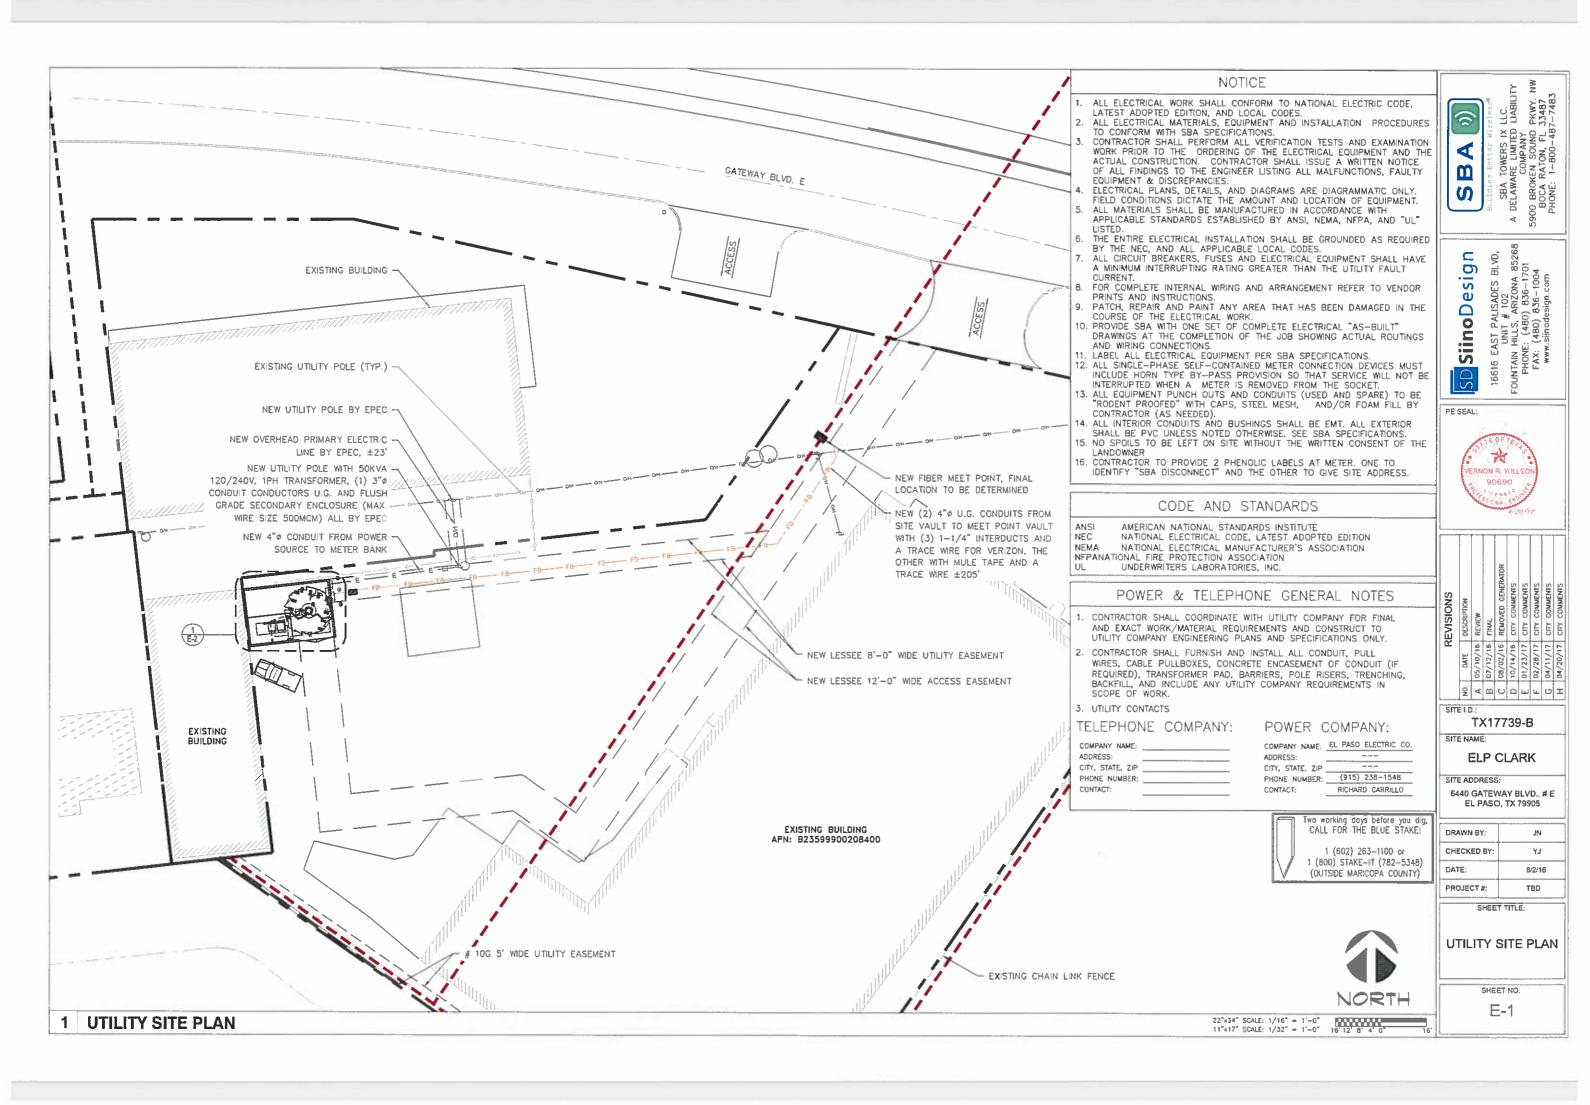

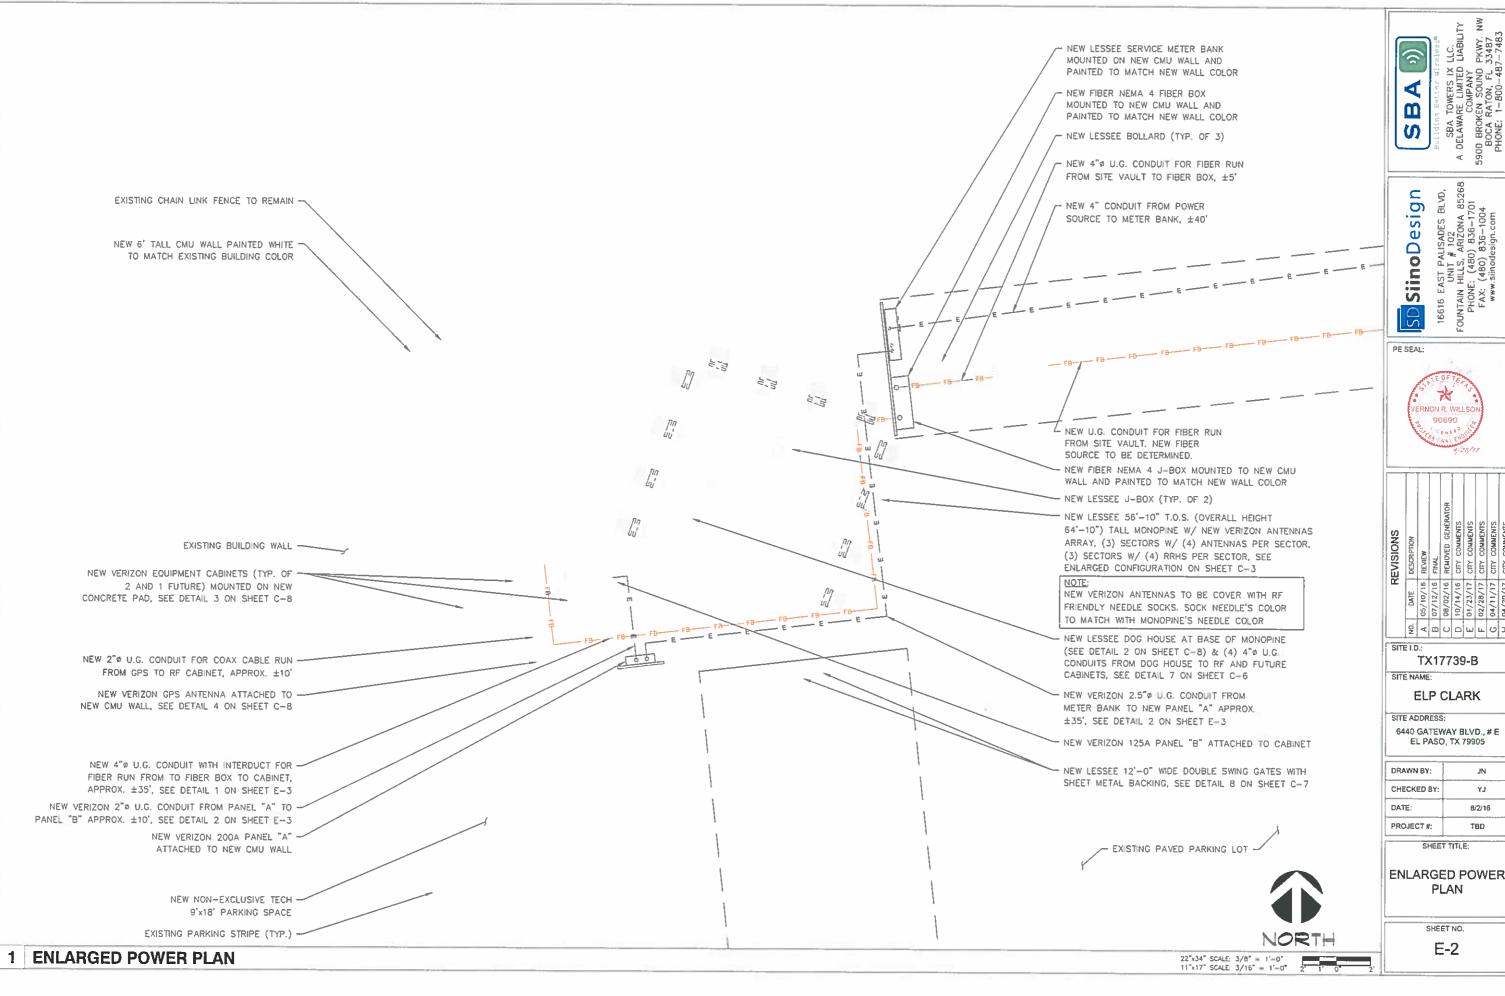





KEVISIONS	DESCRIPTION	REVIEW	FIRM	REMOVED GENERATOR	CITY COMMENTS				
r	DATE	05/10/16	07/12/16	08/05/16	10/14/16	01/23/17	02/28/17	04/11/17	04/20/17
	o.	٨	В	O	۵	w	L	Ŋ	I

DRAWN BY:	JN
CHECKED BY:	LT
DATE:	8/2/16
PROJECT #:	TBD

ENLARGED POWER

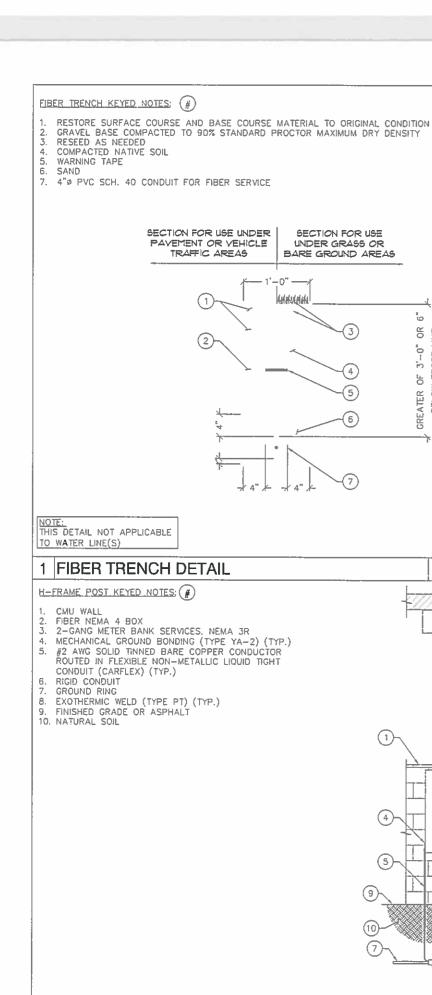

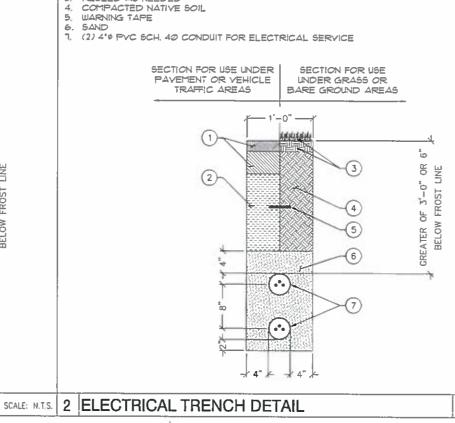

RESTORE SURFACE COURSE AND BASE COURSE MATERIAL TO ORIGINAL

CONDITION
GRAVEL BASE COMPACTED TO 90% STANDARD PROCTOR MAXIMUM DRY

HIGH VOLTAGE TRENCH KEYED NOTES: (#)


DENSITY

SECTION FOR USE

UNDER GRASS OR

BARE GROUND AREAS

RESEED AS NEEDED

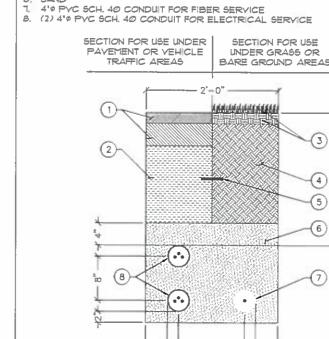

SCALE N.T.S. 3 JOINT UTILITY TRENCH DETAIL

HIGH VOLTAGE TRENCH KEYED NOTES: (#)

CONDITION

RESEED AS NEEDED

COMPACTED NATIVE SOIL WARNING TAPE

DENSITY

SAND

BARE GROUND AREAS OR 0

RESTORE SURFACE COURSE AND BASE COURSE MATERIAL TO ORIGINAL

GRAVEL BASE COMPACTED TO 90% STANDARD PROCTOR MAXIMUM DRY

SBA TOWERS IX LLC.
A DELAWARE LIMITED LIABILITY
COMPANY
5900 BROKEN SOUND PKWY. NW
BOCA RATON, FL 33487
PHONE: 1-800-487-7402 Þ M S

BLVD,

AST PALISADES BLVD, UNIT # 102 HILLS, ARIZONA 8526 E: (480) 836–1701 (480) 836–1004 Ginnodesign.com SiinoDesig 16616 EAST F UNIT OUNTAIN HILLS



SITE I.D. TX17739-B SITE NAME:

ELP CLARK

SITE ADDRESS 6440 GATEWAY BLVD., # E EL PASO, TX 79905


DRAWN BY: JN CHECKED BY YJ DATE: 8/2/16 PROJECT#: TBD


SHEET TITLE:

UTILITY DETAILS

SHEET NO. E-3

33 PLAN

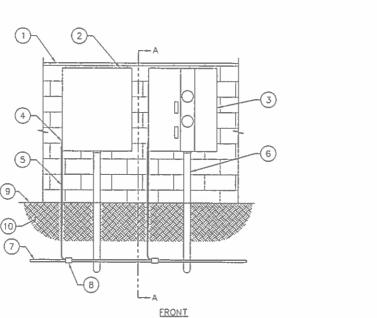

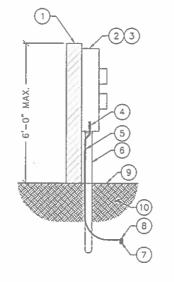

SECTION A-A

4 UTILITY H-FRAME

SCALE: N.T.S

SCALE: N.T.S

NEW				E	1000	TRICAL	PANE	. 5	CHE	HIE				
PANEL: A										JOLE	_			-
LOCATION: AT LEASE AREA	100 Miles 100 Mi									240 / 120 Y 1#,3W				
MOUNTING: SURFACE		MTING: 5	~										MARKS:	200 A MCB
2.DAD	Diff	C3	PHASE	CKT	CR			Lan					BUS:	200 A CU
DESCRIPTION	COND		HELIT	BRKR	NO.	PHASE A	PHASE B	NO.		PHASE	CEU	DAT	1040	
LICHTING & EMERGENCY LICHTING	3/4"	12	12	20	1	8.0	PHINGE B	NO.	20	12	12		RECEPTACIES	
TECH LIGHT (FUTURE)		'*	"	1 1	H	1.3	ł	7	1 1	12	14	3/4"		RECEP (FUTURE)
PANEL		_	_	125	3	1.0	78.5	اث	-			\vdash	BUSSED SPACE	
PANEL 8		SEE	į.	"	-		10.0	1	1			!	BOSSED SPACE	L
PANEL	Pani	EL SCHE	3110	[5	73.5	10.0	÷	-			-	BUSSED SPACE	e
CONT.	'	L 2004		2	ř	10.0	1	1	1				BUSSED SPICE	ž.
BUSSED SPACE					7		0.0	Ť					SME CEZZEUB	E
	J !				_	i	0.0	1	1					-
BUSSED SPACE					P	0.0		Ť					BUSSED SPACE	£ .
						0.0	1	10	1					-
BUSSED SPACE					.11		0.0					$\overline{}$	BUSSED SPACE	E
							0.0	12	1				,	
BUSSED SPACE					15	0.0							RESED SPACE	ξ
					1	0.0		14]					
BUSSED SPACE					13		0.0						BUSSED SPACE	ξ
					L.		0.0	18						
BUSSED SPACE	i !		1		17	0.0		느	1		- 1		BUSSED SPACE	ξ
	<u> </u>	_	_		<u> </u>	0.0		16	ļ				[
BLISSED SPACE	į į		l i	i	10		0.0	_	Į.	:		i	BLESSED SPACE	ξ
			<u> </u>	-	-		0.0	20	-			_		
BLASSED SPACE			i i	i	21	0.0		 	Ì	i I			BUSSED SPACE	E
BUSSED SPACE	-	-	-		-	0.0		22	_	-		_		
BOZSED SPACE		1	İ		23		0.0	24	1	il	i	i	BUSSED SPACE	ξ
BUSSED SPACE				_	25	0.0	0.0	74		-	-	_		
proper of the					-23	0.0		26	1				BNZZED SPACE	L
BUSSED SPACE	-	_			27	9.0	0.0		_		_		BUSSED SPACE	,
	1		1				0.0	28	1					-
BUSSED SPACE					29	0.0		Ť	_			_	BUSSED SPACE	, ,,,,,,,,,,,,,,,,,,,,,,,,,,,,,,,,,,,,,
					-	0.0		30	1					•
AMPS PER PHASE (CODE LDAD)					-	81	76.3	Ë	CONTRA	CTOR TO	MSTALL	APPROV	ED HANCLE TE	ON ALL SHARED
								•		L CHOUR				
1 PHASE DEMAND (KW)											SYMBOL	LIST		
LICHTING							720.0							
25% OF LICHTING	•						180.0							
RECEPTACLES							180.0		_					
MECH (LARGEST) to 1.25%							0.0		\vdash					
									\vdash					
							0.0		\vdash					
							0.0		 			-		
							0.0		<u> </u>					
PANEL					- 1		19,440.0		ļ					
					-		0.0							
					- 1		0.0							
					į		0.0							
TOTAL VA					i		20,520.0							
20.9	IO/A ID	240	Y 10				,,,,,	'						
	A D		¥ 10											
03.3									_					
MEW				27	177	TELCAL	EDT SMILL	- 67	COLCT	THE				

NEW				E	LE	TRICAL	PANEL	. S	CHEI	ULE		_	
PANEL: B	PANEL: B 35KAIC/10KAIC SERIES RATED VOLDGE: 240 / 120 V 16.3V												
									WARS: 125 A NCB				
MOUNTING: SURFACE	NEWA R	ATING: 3	R										BUS: 125 A CU
LOAD	EMT	마	PHASE	CKT	CF.	-	LOAD AMPS	CR	pg	PHASE	QJ	EMT	LOND
DESCRIPTION	COND	CRNQ	NEUT	British	NO.	PHASE A	PHASE B	NO.	BRKR	NEU?	CRIC	CONO	DESCRIPTION
MESC	3/4"	12	8	40	1	13.3			40	a	12	3/4"	wsc
RECTIFIER \$1		,			Г	13.3	1	2	1	'		-	RECTIFIER \$3
MSC		!	a		3		15.3		1	8			MSC
CDHT.				2		1	15.3	4	1 2	1			CDeff.
MSC	3/4"	12	8	40	3	13.5			40	6	12	5/4"	MESC.
RECTIFIER #2			1			13.3	1	6	1	-	"	" '	RECTURER #4
MSC			0		7		15.3	-	1	6			lesc
CONT,		ĺ	l	2	\vdash	1	15.3	a	1 2	-		!	CDMT.
MECH (LARGEST)	3/44	10	10	30	9	20.3	1.3	1	20	8	12	3/4"	MEDEPHICAS
AC#1	'		1		_	0.0	70.3	10	1 7			7 .	OFGI RECEP (POWER CABINET)
MECH (LARGEST)			10	-	31		1.5		20	8	12	3/4"	RECEPTACIES
CONT.	- 1			1 2				12	1 ;	-		1	OFC: RECEP (RF CABINET)
AMPS PER PHASE (CODE LOAD)						73.5	78.5		CONTRACTOR TO INSTALL APPROVED HANDLE TE ON ALL SHARED MENTRAL CIRCLETS.				
1 PHASE DEWAND (KVA)	_								STHROL LIST				
	_						0.0						
	_						0.0						-
RECEPTACLES						380.0							
	_					9.0							
	_						0.0	١.					
MISCELLANEOUS	_						13,466.0	١.					
MECH (LARCEST) @ 125%							0.0908						
							0.0						
	_						0.0	li					
	_						0.0				_		
	_						0.0						
TOTAL VA	_						19,938						
	19.9 (04.0	240	¥ 10										
	0314.0	240	M. 54										

CODE LOAD SUMMARY PANEL 'A' • 240V = 85.5A INCLUDING PANEL 'B'

ALL CIRCUIT BREAKERS AND/OR FUSES SHALL BE SERIES RATED TO WITHSTAND THE MAXIMUM AVAILABLE FAULT CURRENT INDICATED. THE SERIES COMBINATION RATINGS SHALL BE MARKED ON THE EQUIPMENT BY THE MANUFACTURER IN ACCORDANCE WITH

NOTE:
PROVIDE WARNING LABELS FOR BOTH THE PANEL AND MAIN DISCONNECT. THE MARKING SHALL BE READILY VISIBLE AND STATE THE FOLLOWING:

CAUTION - SERIES COMBINATION SYSTEM RATED ___AMPERES. IDENTIFIED REPLACEMENT COMPONENTS REQUIRED.

NOTES:

GENERATOR SHALL COMPLY WITH SECTION 445 OF THE 2011 NEC

GENERATOR NEUTRAL SHALL NOT BE BONDED TO FRAME. IT SHALL BE SOLIDLY CONNECTED THROUGH TRANSFER SWITCH TO SERVICE NEUTRAL.

#6 COPPER WIRE AND COARSER SHALL BE (COPPER) THWN WIRE OR (COPPER) XHHW.
PRIOR TO RUNNING CONDUIT ROUTE — CONTRACTOR SHALL CONTACT THE VERIZON PROJECT MANAGER AND
VERIFY THE EQUIPMENT CABINET LAYOUT CONFIGURATION AND ROUTE CONDUITS ACCORDINGLY.
PRE—CONSTRUCTION MEETING AND ELECTRICAL EASEMENT REQUIRED.

DUAL VOLTAGE SITE. UTILITY POWER IS 208V 10 AND STAND-BY GENERATOR IS 240V 10. ALL EQUIPMENT SHALL BE RATED 240V 10 AND HAVE BEEN VERIFIED TO OPERATE AT 208 VOLTAGE.

FAULT CALCULATIONS

FAULT AVAILABLE AT THE SERVICE: SERVICE VOLTAGE: LLC./PANEL, 'A'
DISTANCE
CONDUIT TYPE
CONDUCTOR
FAULT AVAILABLE L-L:

Panel B
DISTANCE
CONDUST TYPE
CONDUCTOR FAULT AVAILABLE L-L: 10 Feet NONCONDUCTIVE #1 14,371 A

2

NEW SECONDARY ENLOSURE BY EPEC

> NEW PANEL 'A' 25KAIC/10KAIC SERIES RATED

> > 200A 2P 30A 125A 20A -SURGE SUPPRESSOR (12) (13)-G.F.L. (WP)

(N) 2-GANG METERS (METER BANK)

240/120V 16, 3W, 400A, 42KAIC, NEMA 3R

占占

7

(M)

(M)

FUTURE TENANTS

MEM MBJ

2P 125A

NEW PANEL 'B' 25KAIC/10KAIC SERIES RATED (SUPPLIED WITH EQUIPMENT CABINET)

ONE-LINE DIAGRAM

CONSTRUCTION KEYED NOTES: (#)

4°C (PVC) - (3) #500mcm CU APPROX. 40° NEW 400A 120/ 240V 1PH SES MULTI-METER PACK WITH (2) 200A METER SOCKETS/DISCONNECTING MEANS MOUNTED ON H-FRAME BY CONTRACTOR PER EPEC SPECS.

3/4°C (PVC) WITH #2 AWG TO 5/8"ø x 8'L GROUND ROD 2-1/2"C. (PVC) - (3) #4/0 + (1) #4 GND. APPROX. 35' NOT USED

NOT USED

PANEL "A", 200A, 2P, 25KVAIC, 120/204V, 1¢, 3W, NEMA 3R

8. 3/4"C (PVC) - (2) #12 + (1) #12 GND. 9. 1-1/2"C. (PVC) - (3) #1 + (1) #8 GND. APPROX. 10'



AST PALISADES BLVD, UNIT # 102 HILLS, ARIZONA 852(E: (480) 836–1701 (480) 836–1004 «.siinodesign.com

SiinoDesig 16616 EAST F UNIT FOUNTAIN HILLS PHONE: (48 FAX: (480 SD

PE SEAL:



REVISIONS	DESCRIPTION	REVIEW	FINAL	REMOVED GENERATOR	CITY COMMENTS	CITY COMMENTS	CITY COMMENTS	CITY COMMENTS	CITY CONNENTS
œ	DATE	05/10/16	07/12/16	08/02/16	10/14/16	01/23/17	02/28/17	04/11/17	04/20/17
	NO.	٨	В	ပ	٥	ш	L.	S	Ξ

SITE I.D.: TX17739-B

SITE NAME:

ELP CLARK

6440 GATEWAY BLVD., # E EL PASO, TX 79905

Ľ		
	DRAWN BY:	NL
	CHECKED BY:	٨٦
	DATE:	8/2/16
ľ	PROJECT#:	TBD

SHEET TITLE:


SINGLE LINE **DIAGRAM & PANEL** SCHEDULE

SHEET NO.

E-4

SINGLE-LINE DIAGRAM & PANEL SCHEDULE

SCALE: N.T.S.

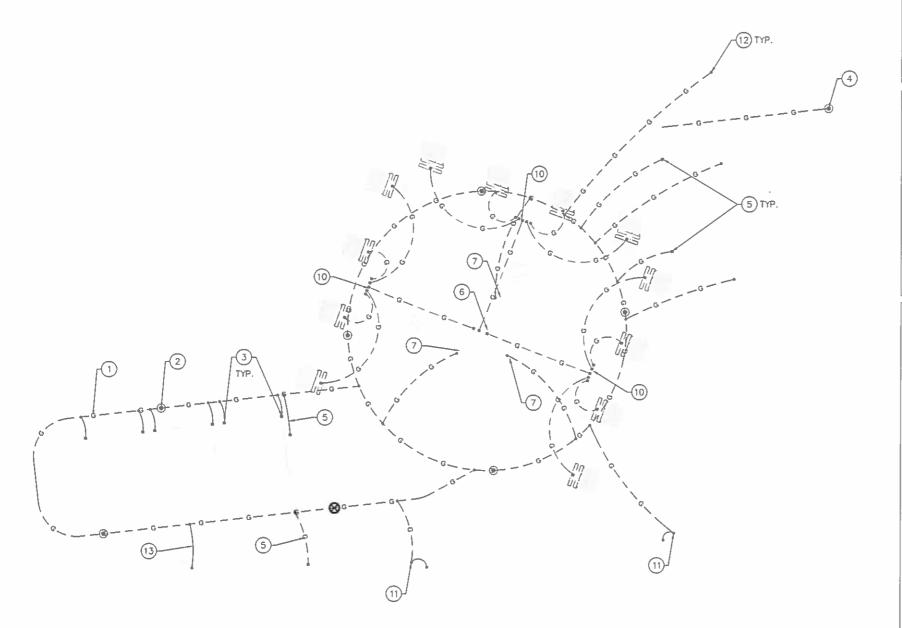



LEGEND:

TINNED SOLID ALLOY 110 COPPER TOWER /ANTENNA BUS BAR BONDED TO MONOPINE STEEL

TEST WELL, REFER TO DETAIL 5 ON SHEET EG-2 Ø

 $5/8^{\prime\prime}$ DIA, \times 8^{\prime} COPPER CLAD GROUND ROD. REFER TO DETAIL 4 ON SHEET EG-2

GROUND RING

EXOTHERMIC WELD OR IRREVERSIBLE HIGH-COMPRESSION CRIMP

MECHANICAL CONNECTION

GENERAL NOTES:

FAG8--I

- A. THESE DRAWINGS REPRESENT THE GENERAL EXTENT AND ARRANGEMENT OF SYSTEMS, BUT ARE NOT TO BE CONSIDERED FABRICATION DRAWINGS.

 COORDINATE WITH OTHER TRADES, AND PROVIDE EACH SYSTEM COMPLETE, INCLUDING ALL NECESSARY COMPONENTS, FITTINGS AND OFFSETS.
- B. INSTALL SYSTEMS SUCH THAT REQUIRED CLEARANCE AND SERVICE ACCESS SPACE IS PROVIDED AROUND ALL MECHANICAL AND ELECTRICAL EQUIPMENT, AND AROUND ANY COMPONENTS WHICH REQUIRE SERVICE ACCESS.
- C. PROVIDE SUPPLEMENTARY STEEL AS REQUIRED FOR THE PROPER SUPPORT OF ALL SYSTEMS.
- D. REFER TO EG-2 FOR GROUNDING DETAILS.
- E. ALL METALLIC SURFACES SHALL BE PREPARED PRIOR TO BONDING, COLD GALV. SPRAY SHALL BE USED ON ANY EXOTHERMIC WELD TO PREVENT CORROSION, ANY AREA TO BE COLD GALV. SPRAY SHALL BE TAPED OFF PRIOR TO APPLICATION.

CONSTRUCTION KEYED NOTES:

- GROUNDING ELECTRODE CONDUCTOR SYSTEM (GROUND RING), #2 AWG SOLID BARE TINNED COPPER CONDUCTOR. GROUNDING ELECTRODE CONDUCTOR SHALL BE BURIED 30" BELOW GRADE WHERE APPLICABLE. ABOVE GRADE GROUNDING ELECTRODE CONDUCTOR TO BE ROUTED IN FLEXIBLE NON-METALLIC LIQUID TIGHT CONDUIT & FASTENED TO CONCRETE SURFACE EVERY 3' MAX. FASTENERS SHALL BE FLEXIBLE CONDUIT HALF STRAPS W/ 1/4" o x 2" (L) RED HEAD HAMMER-SET NAIL DRIVE ANCHOR OR EQUIV.
- 2. 5/8" DIA. x 8' LONG COPPER CLAD GROUND ROD PLACED MINIMUM EVERY 8' APART, SEE DETAIL 4 ON SHEET EG-2.
- 3. BOND CABINET FRAMING TO GROUND RING PER CABINET MANUFACTURER SPECS (TYP.), SEE DETAIL 8 ON SHEET EG-2.
- 4. 5/8" DIA. x 8' LONG COPPER CLAD GROUND ROD PLACED MINIMUM EVERY 8' APART. SEE DETAIL 4 ON SHEET EG-2.
- 5. BOND ELETRICAL EQUIPMENT HOUSING TO GROUND RING, SEE DETAIL 4 ON SHEET EG-2.
- TOWER GROUND BUS BAR. BOND TO GROUND RING WITH #2 AWG SOLID TINNED BARE COPPER CONDUCTOR. BOND TO TOWER GROUND BUS BAR DIRECTLY TO TOWER STEEL. SEE DETAIL 6 ON SHEET EG-2.
- BOND POLE BASE PLATE (AT MANUFACTURER INSTALLED BONDING TAB) TO GROUND RING. UNDER NO CIRCUMSTANCES WILL EXOTHERMIC WELDING BE PERMITTED ON THE POLE TRUNK, TYPICAL 3 LOCATIONS. SEE DETAIL 3 ON
- 8. ANCILLARY METALLIC EQUIPMENT, BOND TO GROUND RING WITH #2 AWG SOLID TINNED BARE COPPER CONDUCTOR (TYP).
- PROVIDE A GROUND LEAD FROM THE GROUND RING TO THE GENERATOR HOUSING, BONDING ON THE GENERATOR HOUSING SHALL BE MECHANICAL
- 10. ANTENNA GROUND BUS BAR. SEE DETAIL 9 ON SHEET EG-2.
- 11. BOND GATE TO GATE POST VIA #2 GATE BOND JUMPER.
- 12. PROVIDE CONCRETE ENCASED ELECTRODE AT BOLLARDS.
- 13. BOND GPS SUPPORTING PIPE TO GROUND RING WITH #2 AWG.
- 14. TEST WELL, REFER TO DETAIL 5 ON SHEET EG-2



8 VST PALISADES BLVD UNIT # 102 HILLS, ARIZONA 852: :: (480) 836–1701 (480) 836–1704 r.siinodesign.com 0 esi Siino FOUNTAIN HILLS, PHONE: (48° FAX: (4° WW.

PE SEAL:



REVISIONS	DESCRIPTION	REVIEW	FINAL	REMOVED GENERATOR	CITY COMMENTS					
LE .	DATE	05/10/16	07/12/16	08/02/16	10/14/16	01/23/17	02/28/17	04/11/17	04/20/17	
	νQ.	⋖	В	O	٥	ы	ш	C	I	

SITE LD: TX17739-B

SITE NAME:

ELP CLARK

6440 GATEWAY BLVD., # E EL PASO, TX 79905

1	
DRAWN BY:	JN
CHECKED BY:	ΥJ
DATE:	8/2/16
PROJECT#:	TBD

SHEET TITLE:


GROUNDING PLAN & NOTES


SHEET NO.

EG-1

1 SITE GROUNDING PLAN

22"x34" SCALE: 1/2" = 1'-0" 11"x17" SCALE: 1/4" = 1'-0"

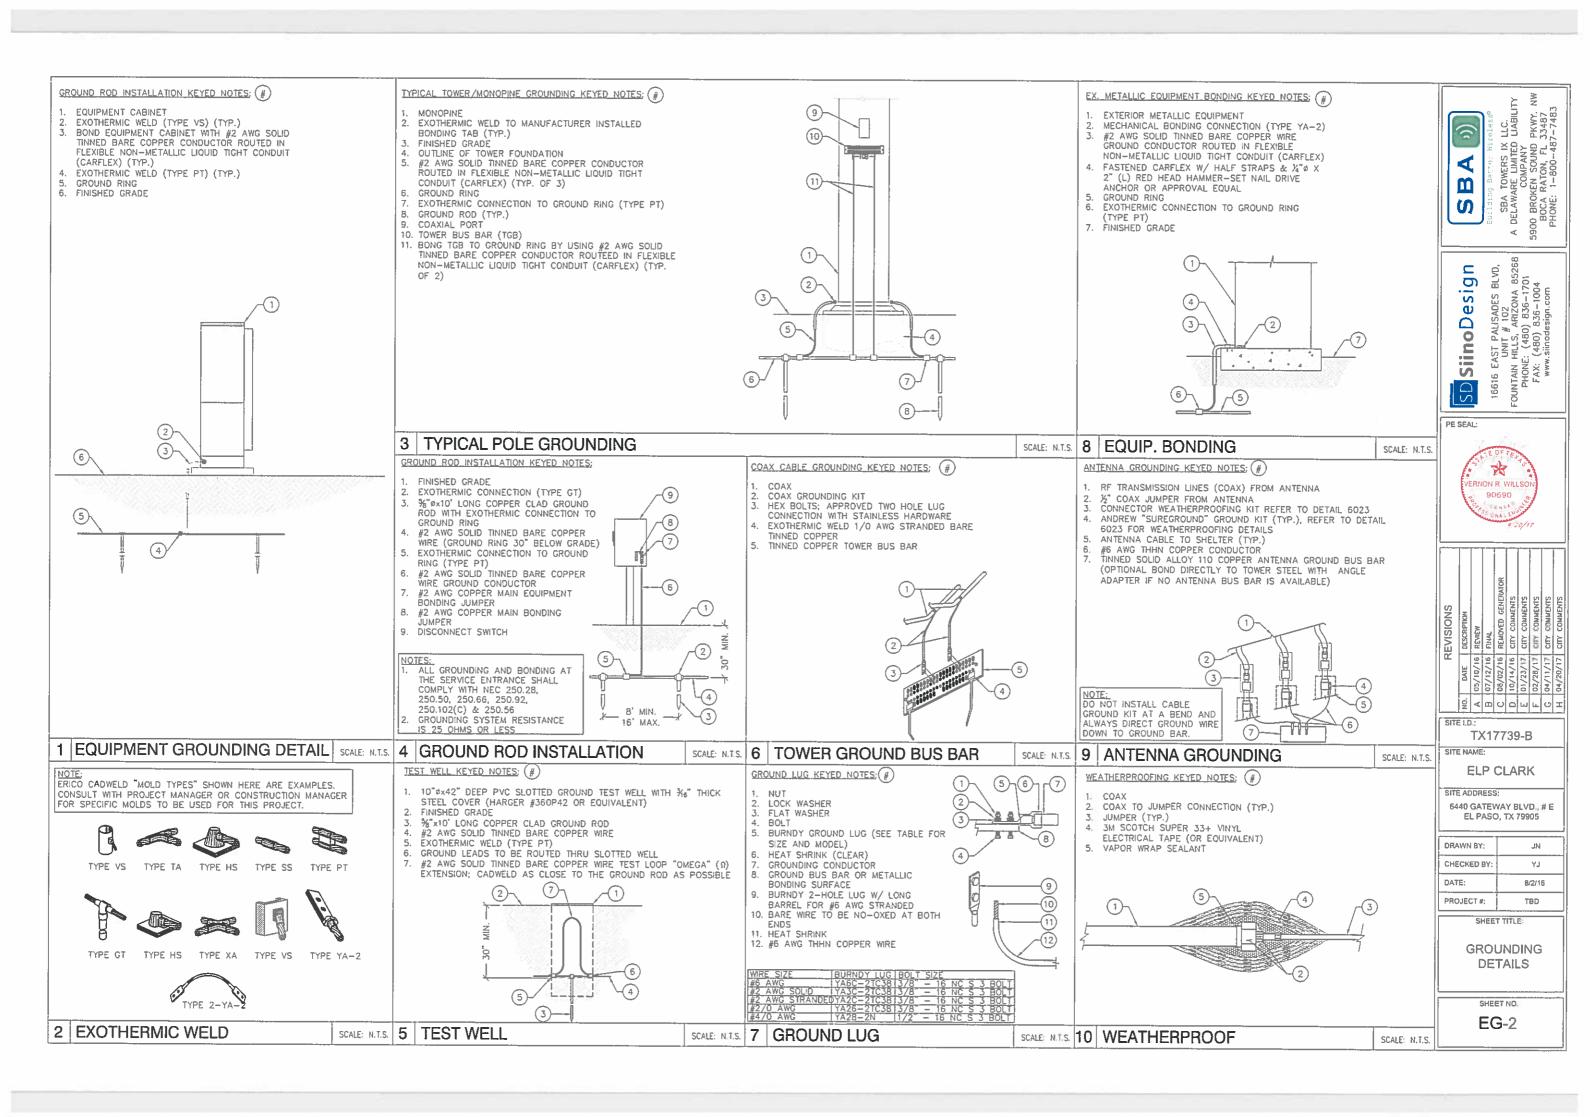

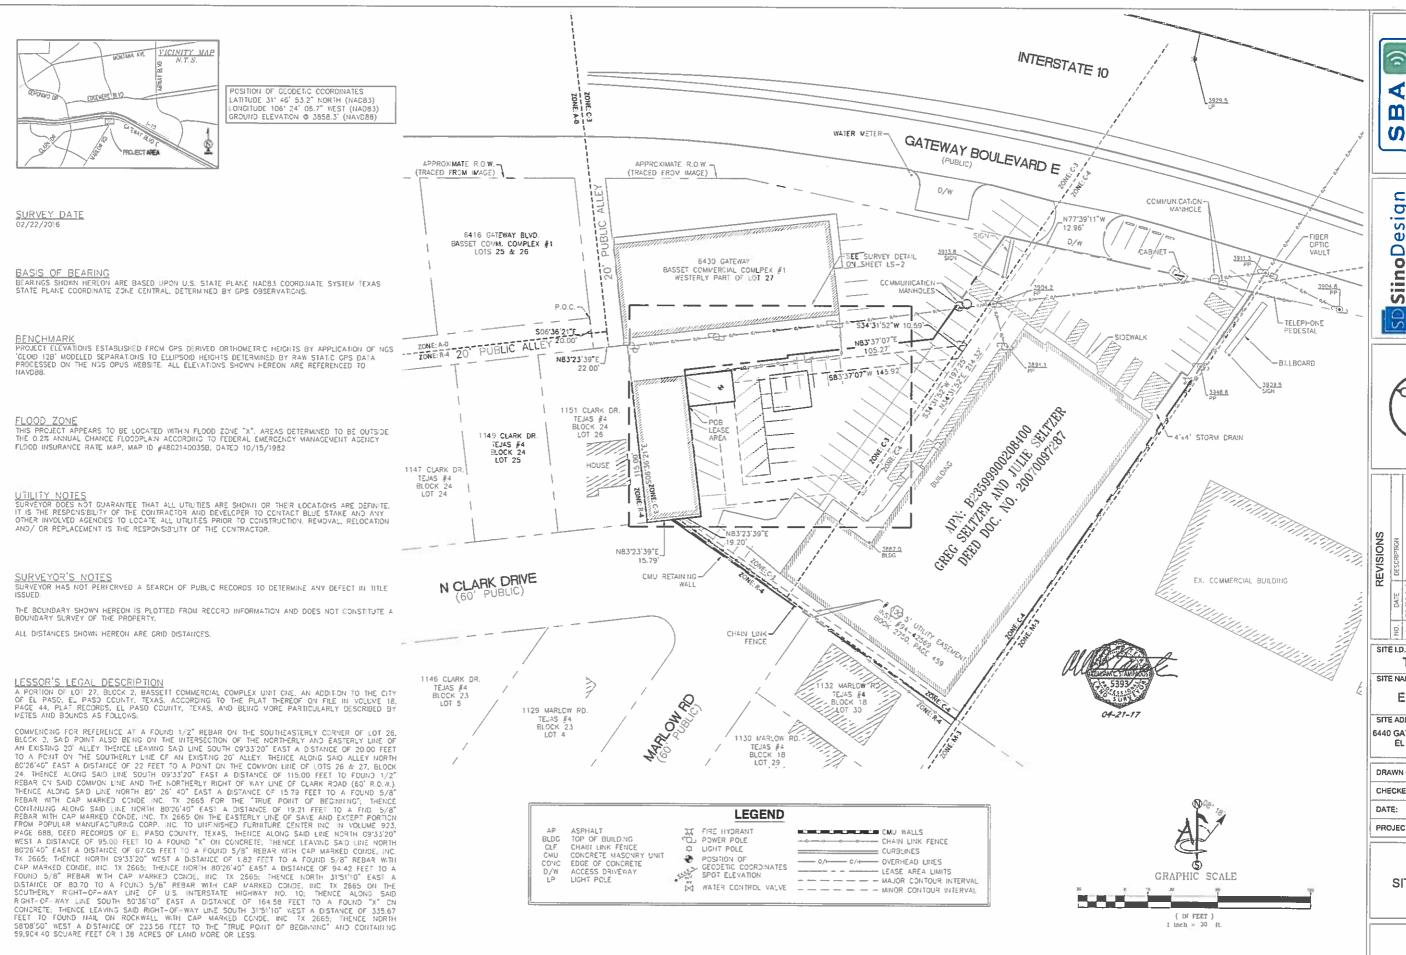

્ર < m

×윤: S

BOCA PHONE:

esign SiinoD

EAST UNI N HILL 91991

TX17739-B SITE NAME:

ELP CLARK

SITE ADDRESS: 6440 GATEWAY BOULEVARD E

DRAWN BY: CK CHECKED BY SB DATE: 03/02/16 PROJECT #: TBD

EL PASO, TX 79905

SHEET TITLE

SITE SURVEY

SHEET NO.

LS-1

LEASE AREA LEGAL DESCRIPTION

A PORTION OF DEED DOCUMENT NO. 20070097287, EL PASO COUNTY RECORDS, TEXAS: ALSO BEING A PORTION OF LOT 27. BLOCK 2. BASSETT COMMERCIAL PASO COUNTY, TEXAS, AND BEING MORE PARTICULARLY DESCRIBED BY METES AND BOUNDS AS

COMMENCING FOR REFERENCE AT THE SOUTHEASTERLY CORNER OF LOT 26, BLOCK 2, SAID POINT ALSO BEING ON THE INTERSECTION OF THE NORTHERLY AND EASTERLY LINE OF AN EXISTING 20' ALLEY THENCE LEAVING SAID LINE SOUTH BG'36'21' FAST A DISTANCE OF 20.00 FEET TO A POINT ON THE SOUTHERLY LINE OF AN EXISTING 20' ALLEY; THENCE ALONG SAID ALLEY NORTH B3'23'39' EAST A DISTANCE OF 22.00 FEET TO THE POINT ON THE COMMON LINE OF LOTS 28 & 27, BLOCK 24; THENCE ALONG SAID LINE SOUTH OB'35'21' EAST A DISTANCE OF 115.00 FEET TO THE THE CONTROL OF SAID COMMON LINE OF LOTS 20 & 27, STOCK Z4; HENCE ALONG SAID LINE SDUTH 65'35'21" EAST A DISTANCE OF 115.00 FEET TO THE INTERSCRICTION OF SAID COMMON LINE AND THE NORTHERLY RIGHT OF WAY LINE OF CLARK ROAD (60' R.O.W.); THENCE ALONG SAID LINE NORTH 83' 23' 39" EAST A DISTANCE OF 15.79 FEET; THENCE CONTINUING ALONG SAID LINE NORTH 83'23'39" EAST A DISTANCE OF 19.20 FEET TO THE EASTERLY LINE OF "SAVE AND EXCEPT" PORTION FROM POPULAR MANUFACTURING CORP. INC. TO UNFINISHED FURNITURE CENTER INC. IN YOLUME 923, PAGE 688, DEED RECORDS OF EL PASO COUNTY, TEXAS; THENCE ALONG SAID LINE NORTH 06'36'21" WEST A DISTANCE OF 71.18 FEET TO THE POINT OF BEGINNING; THENCE CONTINUING NORTH 06'36'21" WEST, 20.00 FEET; THENCE NORTH 83'23'39" EAST, 30.00 FEET; THENCE SOUTH 83'23'39" WEST, 30.00 FEET TO THE POINT OF BEGINNING.

CONTAINING 600 SQUARE FEET (0.014 ACRES) OF LAND, MORE OR LESS.

ACCESS FASEMENT LEGAL DESCRIPTION

A PORTION OF DEED DOCUMENT NO. 20070097287. EL PASO COUNTY RECORDS, TEXAS: ALSO BEING A PORTION OF LOT 27, BLOCK 2, BASSETT COMMERCIAL COMPLEX UNIT ONE, AN ADDITION TO THE CITY OF EL PASO, EL PASO COUNTY, TEXAS, ACCORDING TO THE PLAT THEREOF ON FILE IN VOLUME 18, PAGE 44, PLAT RECORDS, EL PASO COUNTY, TEXAS, AND BEING MORE PARTICULARLY DESCRIBED BY METES AND BOUNDS AS

COMMENCING FOR REFERENCE AT THE SOUTHEASTERLY CORNER OF LOT 26, BLOCK 2, SAID POINT ALSO BEING ON THE INTERSECTION OF THE NORTHERLY AND EASTERLY LINE OF AN EXISTING 20' ALLEY THENCE LEAVING SAID LINE SOUTH 06'35'21" EAST A DISTANCE OF 20.00 FEET TO A POINT ON THE SOUTHERLY LINE OF AN EXISTING 20' ALLEY THENCE ALONG SAID ALLEY BOOTH 83'23'39" EAST A DISTANCE OF 22.00 FEET TO A POINT ON THE COMMON LINE OF LOTS 26 & 27, BLOCK 24; THENCE ALONG SAID LINE SOUTH 06'35'21" EAST A DISTANCE OF 115.00 FEET TO THE INTERSECTION OF SAID COMMON LINE AND THE NORTHERLY RIGHT OF WAY LINE OF CLARK ROAD (60' R.O.W.): THENCE ALONG SAID LINE NORTH 83'23'39" EAST A DISTANCE OF 19.20 FEET TO THE EASTERLY LINE OF "SAYE AND EXCEPT" PORTION FROM POPULAR MANUFACTURING CORP. INC. TO UNFINISHED FURNITURE CENTER INC. IN VOLUME 923, PACE 68B. DEED RECORDS OF EL PASO COUNTY, TEXAS; THENCE ALONG SAID LINE NORTH 06'36'21" AEST A DISTANCE OF 71.18 FEET; THENCE DEPARTING SAD LINE, NORTH 83'23'39" EAST A DISTANCE OF 71.18 FEET; THENCE DEPARTING SAD LINE, NORTH 83'23'39" EAST A DISTANCE OF 19.20 FEET TO THE POINT OF RECONNING; THENCE SOUTH 06'16'05' EAST 64.05 FEET THENCE EXPIRIT BASTER'S FEAT THE ASTINGE PAST 24.05 FEET; THENCE EXPIRIT BASTER'S FEAT THENCE SOUTH 63'16'05' EAST 64.05 FEET, THENCE EXPIRIT BASTER'S FEAT TO ALS FEET. THENCE EXPIRIT BASTER'S FEAT THENCE SOUTH 63'16'05' FAST 164.05 FEET, THENCE EXPIRIT BASTER'S FAST 30'15 FEET TO THE POINT OF RECONNING; THENCE SOUTH 06'16'05' EAST 64.05 FEET, THENCE EXPIRIT BASTER'S FAST 30'15 FERTENCE AND FAST 30'15 FEET TO THE POINT OF RECONNING; THENCE SOUTH 06'16'05' FAST 164.05 FEET, THENCE EXPIRIT BASTER'S FAST 30'15 FEET THENCE MOBILE OF THE PROPRIET OF THE PART ASTAT 30'15 FEET THENCE PART ASTAT 30'15 FEET TO THE POINT OF RECONNING; THENCE SOUTH 05'16'05' FAST 164.05 FEET THE PART BAST 30'15 FEET TO THE POINT OF RECONNING; THENCE SOUTH 05'16'05' FAST 164.05' FAST 164.0 THENCE NORTH B334-55 EAST 67.04 FEET; THENCE SOUTH 5438-26 EAST 30.13 FEET; THENCE NORTH 3431-52 EAST 214.32 FEET; THENCE NORTH 77/39/11 WEST 12.95 FEET; THENCE SOUTH 3431-52 WEST, 197.25 FEET; THENCE NORTH 5438-26 WEST, 22.53 FEET; THENCE SOUTH 83/34-55 WEST 59.59 FEET; THENCE NORTH 06/16/06 WEST 54.10 FEET; THENCE SOUTH 83/25/39 WEST 12.00 FEET TO THE POINT OF BEGINNING.

CONTAINING 2,486 SQUARE FEET (0,057 ACRES) OF LAND, MORE OR LESS.

UTILITY EASEMENT LEGAL DESCRIPTION
A PORTION OF DEED DOCUMENT NO. 20070007287, EL PASO COUNTY RECORDS, IEXAS: ALSO BEING A PORTION OF LDT 27. BLOCK 2.
BASSETT COMMERCIAL COMPLEX UNIT ONE, AN ADDITION TO THE CITY OF EL PASO, EL PASO COUNTY, TEXAS, ACCORDING TO THE PLAT THEREOF OF
FILE IN YOLUME 18, PAGE 44, PLAT RECORDS, EL PASO COUNTY, TEXAS, AND BEING MORE PARTICULARLY DESCRIBED BY METES AND BOUNDS AS

COMMENCING FOR REFERENCE AT THE SOUTHEASTERLY CORNER OF LOT 26, BLOCK 2, SAID POINT ALSO BEING ON THE INTERSECTION OF THE NORTHERLY AND EASTERLY LINE OF AN EXISTING 20' ALLEY THENCE LEAVING SAID LINE SOUTH 06'38'21' EAST A DISTANCE OF 20.00 FEET TO A POINT ON THE SOUTHERLY LINE OF AN EXISTING 20' ALLEY, THENCE ALONG SAID LINE SOUTH 06'38'21' EAST A DISTANCE OF 12.00 FEET TO A POINT ON THE COMMON LINE OF LOTS 26 & 27, BLOCK 24' THENCE ALONG SAID LINE SOUTH 06'38'21' EAST A DISTANCE OF 15.00 FEET TO THE INTERSECTION OF SAID COMMON LINE AND THE NORTHERLY RIGHT OF WAY LINE OF CLARK ROAD (60' R.O.W.); THENCE ALONG SAID LINE NORTH 83'23'39' EAST A DISTANCE OF 19.20 FEET TO THE EASTERLY LINE OF "SAVE AND EXCEPT" PORTION FROM POPULAR MANUFACTURING CORP. INC. TO UNFINISHED FURNITURE CENTER INC, IN VOLUME 923, PACE 688, DEED RECORDS OF EL PASD COUNTY, TEXAS; THENCE ALONG SAID LINE NORTH 65'21' WEST A DISTANCE OF 91.18 FEET; THENCE NORTH 63'23'39' EAST AS OFFER TO THE POINT OF BEGINNING; THENCE NORTH 83'35'07' EAST 4.00G SAID NORTH LINE, 5.00 FEET; THENCE LOPARTING SAID LINE NORTH 85'23'39' EAST ALONG SAID NORTH LINE, 5.00 FEET; THENCE DEPARTING SAID HORTH LINE SCUTH 06'22'53' EAST, 5.83 FEET; THENCE NORTH 83'37'07' EAST, LONG SAID NORTH LINE, 5.00 FEET; THENCE DEPARTING SAID HORTH LINE SCUTH 06'32'53' EAST, 5.83 FEET; THENCE NORTH B3'33'707' EAST, 105.27 FEET TO AN ACCESS AND UTILITY EASEMENT, THENCE SOUTH 34'31'52' WEST ALONG SAID NORTH LINE, 5.00 FEET; THENCE DEPARTING SAID HORTH LINE SOUTH 63'33'67' WEST ALONG SAID NORTH LINE, 5.00 FEET; THENCE NORTH 06'36'21' EAST ALONG SAID NORTH LINE, 5.00 FEET; THENCE NORTH 06'36'21' WEST ALONG SAID NORTH LINE, 5.00 FEET; THENCE NORTH 06'36'21' EAST ALONG SAID NORTH LINE, 5.00 FEET; THENCE NORTH 06'36'21' EAST ALONG SAID NORTH LINE, 5.00 FEET; THENCE NORTH 06'36'21' EAST ALONG SAID NORTH LINE, 5.00 FEET; THENCE NORTH 06'36'21' EAST ALONG SAID NORTH LINE, 5.00 FEET; THENCE NORTH 06'36'21' EAST ALONG SAID NORTH LINE, 5.00 FEET; THENCE NORTH 06'36'21' EAST ALONG SAID NORTH LINE, 5.00 FEET: THENCE NORTH 06'36'21" EAST 8 00 FEET TO THE POINT OF BEGINNING.

CONTAINING 1,929 SQUARE FEET (0.043 ACRES) OF LAND, MCRE OR LESS.

REFERENCE IS MADE TO THE TITLE REPORT ORDER #16029254, ISSUED BY OLD REPUBLIC TITLE INSURANCE COMPANY, DATED MARCH 30, 2016. ALL EASEMENTS CONTAINED WITHIN SAID TITLE REPORT AFFECTING THE IMMEDIATE AREA SURROUNDING THE LEASE HAVE BEEN PLOTTED.

ITEMIZED NOTES: SCHEDULE "8" ITEM NUMBERS 1 THROUGH 9 AS WELL AS 10A THROUGH 10E AND 10L THROUGH 10N ARE NOT SURVEY MATTERS, OR, HAVE NO EFFECT IN THE AREA OF THIS SURVEY. 10F TELEPHONE EASEMENT RECORDED IN BOOK 1257, PACE 359 REAL PROPERTY RECORDS OF EL PASO COUNTY, TEXAS - UNABLE TO DELINEATE

- UTILITY EASEMENT RECORDED AS INSTRUMENT NUMBER 94-42569 IN BOOK 2750, PAGE 459 REAL PROPERTY RECORDS OF EL PASO COUNTY, TEXAS SHOWN AND NOTED HEREON, NO CONFLICT WITH LEASE AREA
- 10H DELETED FROM REPORT NOTHING TO SHOW
- 10# ELECTRIC EASEMENT RECORDED MARCH 23, 2006 AS INSTRUMENT NUMBER 20050026087, OFFICIAL PUBLIC RECORDS OF EL PASO COUNTY, TEXAS LIES TO THE EAST BEYOND THE SCOPE OF THIS SURVEY, NO CONFLICT WITH LEASE AREA
- 10. ELECTRIC EASEMENT RECORDED SEPTEMBER 10, 2003 AS INSTRUVENT NUMBER 20030088038 IN BOOK 4677, PAGE 842, OFFICIAL PUBLIC RECORDS OF EL PASO COUNTY, TEXAS LIES TO THE EAST BEYOND THE SCOPE OF THIS SURVEY, NO CONFLICT MITH LEASE AREA
- 10K CONTRACT FOR REZONING AND RESTRICTIONS RECORDED IN BOOK 492, PAGE 1351 AND IN BOOK 656, PAGE 8, REAL PROPERTY RECORDS OF EL PAGO COUNTY, TEXAS NOT A SURVEY WATTER, NOTHING TO SHOW

SURVEYOR'S CERTIFICATION

HEREBY CERTIFY TO SBA TOWERS IX. LLC, A DELAWARE LIMITED LIABLITY COMPANY AND OLD REPUBLIC NATIONAL TITLE INSURANCE COMPANY, THE


THIS SURVEYOR HAS RECEIVED AND REFERVED THAT CERTAIN TITLE REPORT COMMITMENT NO. 16029254, ISSUED BY OLD REPUBLIC NATIONAL TITLE INSURANCE COMPANY WITH AN EFFECTIVE DATE OF MARCH 30, 2016 WHICH PROPOSES TO INSURE THE LANDS DESCRIBED UNDER ITS SCHEDULE A.

THS SURVEYOR KNOWS OF HIS OWN KNOWLEDGE THAT THE LANDS DESCRIBED UNDER SAID SCHEDULE A OF THE TITLE COMMITMENT CONTAIN OR INCLUDE THE LANDS DESCRIBED IN AND DEPICTED ON THIS SURVEY.

CAS TO SEE BUUCHOS ROUND DETITING ON CARD TO STANDARD THE SUBJECT SENT OF STANDARD SHIP ROYAND SHIP STANDARD OF ST PARCELS. THERE MAY BE POSSIBLE CONFLICTS WITH TITLE REPORT EXCEPTION \$10F.

FURTHER CERTIFY THAT ALL PARTS OF THIS SURVEY AND DRAWING HAVE BEEN COMPLETED IN ACCORDANCE WITH THE CURRENT REQUIREMENTS OF THE STANDARDS OF PRACTICE FOR SURVEYING IN THE STATE OF TEXAS TO THE BEST OF MY KNOWLEDGE, MFORMATION, AND BELIEF.

WILLIAM C. STAMPADOS, R.P.L.S. 5393 DATE

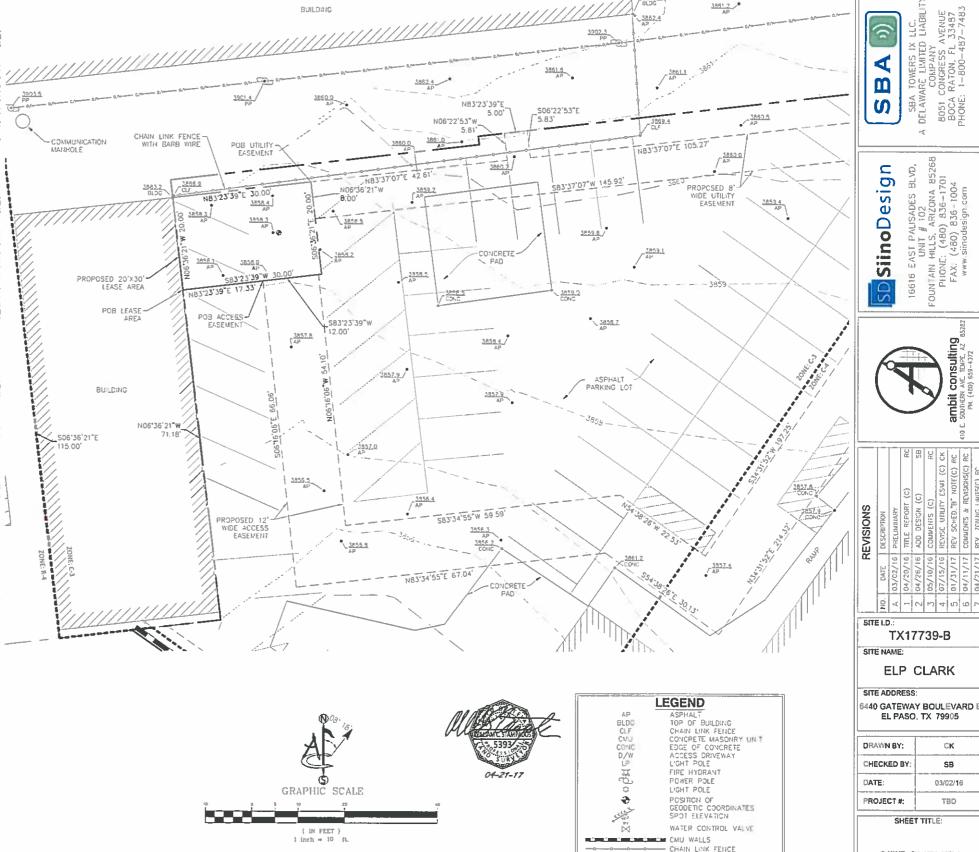

હ

⋖

m

S

6

·Si

O

SiinoD

| 6616 EAST PALISADES BLVD UNIT # 102 UNIT # 102 PHONE: (480) 836-1701 FAX: (480) 836-1004 www.sinodesign.com

91991

TX17739-B

ELP CLARK

EL PASO, TX 79905

SHEET TITLE

SITE SURVEY

SHEET NO.

LS-2

CURBLINES

--- - MINOR CONTOUR INTERVAL

O/I---- OVERHEAD LINES -- LEASE AREA LIMITS - - - - - - MAJOR CONTOUR INTERVAL CK

SB

03/02/16

TBD

GENERAL NOTES

- 1. ALL REFERENCES TO OWNER HEREIN SHALL BE CONSTRUED TO MEAN SBA OR IT'S DESIGNATED REPRESENTATIVE.
- 2. ALL WORK PRESENTED ON THESE DRAWINGS MUST BE COMPLETED UNLESS NOTED OTHERWISE. THE CONTRACTOR MUST HAVE CONSIDERABLE EXPERIENCE IN PERFORMANCE OF WORK SIMILAR TO THAT DESCRIBED HEREIN. BY ACCEPTANCE OF THIS ASSIGNMENT, THE CONTRACTOR IS ATTESTING THAT HE DOES HAVE SUFFICIENT EXPERIENCE AND ABILITY THAT HE IS KNOWLEDGEABLE OF THE WORK TO BE PERFORMED AND THAT HE IS LICENSED AND PROPERLY REGISTERED TO DO THIS WORK IN THE STATE AND/OR COUNTY IN WHICH IT IS TO BE PERFORMED.
- 3. UNLESS SHOWN OR NOTED OTHERWISE ON THE CONTRACT DRAWINGS, OR IN THE SPECIFICATIONS. THE FOLLOWING NOTES SHALL APPLY TO THE MATERIALS LISTED HEREIN, AND TO THE PROCEDURES TO BE USED ON THIS PROJECT.
- 4. ALL HARDWARE ASSEMBLY MANUFACTURER'S INSTRUCTIONS SHALL BE FOLLOWED EXACTLY AND SHALL SUPERCEDE ANY CONFLICTING NOTES ENCLOSED HEREIN.
- 5. IT IS THE CONTRACTOR'S SOLE RESPONSIBILITY TO DETERMINE ERECTION PROCEDURE AND SEQUENCE TO INSURE THE SAFETY OF THE STRUCTURE AND ITS COMPONENT PARTS DURING ERECTION AND/OR FIELD MODIFICATIONS. THIS INCLUDES, BUT IS NOT LIMITED TO, THE ADDITION OF WHATEVER TEMPORARY BRACING, GUYS OR TIE DOWNS THAT MAY BE NECESSARY, SUCH MATERIAL SHALL BE REMOVED AND SHALL REMAIN THE PROPERTY OF THE CONTRACTOR AFTER COMPLETION OF THE
- 6. ALL DIMENSIONS, ELEVATIONS AND EXISTING CONDITIONS SHOWN ON THE DRAWINGS SHALL BE FIELD VERIFIED BY THE CONTRACTOR AND THE TESTING AGENCY PRIOR TO BEGINNING ANY MATERIALS ORDERING, FABRICATION OR CONSTRUCTION WORK ON THIS PROJECT. ANY DISCREPANCIES SHALL BE IMMEDIATELY BROUGHT TO THE ATTENTION OF THE OWNER AND THE OWNER'S ENGINEER. THE DISCREPANCIES MUST BE RESOLVED BEFORE THE CONTRACTOR IS TO PROCEED WITH THE WORK, THE CONTRACT DOCUMENTS DO NOT INDICATE THE METHOD OF CONSTRUCTION. THE CONTRACTOR SHALL SUPERVISE AND DIRECT THE WORK AND SHALL BE SOLELY RESPONSIBLE FOR ALL CONSTRUCTION MEANS, METHODS, TECHNIQUES, SEQUENCES AND PROCEDURES, OBSERVATION VISITS TO THE SITE BY THE OWNER AND/OR THE ENGINEER SHALL NOT INCLUDE INSPECTION OF THE PROTECTIVE MEASURES OR THE CONSTRUCTION PROCEDURES.
- 7. ALL MATERIALS AND EQUIPMENT FURNISHED SHALL BE NEW AND OF GOOD QUALITY, FREE FROM FAULTS AND DEFECTS AND IN CONFORMANCE WITH THE CONTRACT DOCUMENTS. ANY AND ALL SUBSTITUTIONS MUST BE PROPERLY APPROVED AND AUTHORIZED IN WRITING BY THE OWNER AND ENGINEER PRIOR TO INSTALLATION. THE CONTRACTOR SHALL FURNISH SATISFACTORY EVIDENCE AS TO THE KIND AND QUALITY OF THE MATERIALS AND EQUIPMENT BEING SUBSTITUTED.
- 8. THE CONTRACTOR SHALL BE RESPONSIBLE FOR INITIATING. MAINTAINING AND SUPERVISING ALL SAFETY PRECAUTIONS AND PROGRAMS IN CONNECTION WITH THE WORK. THE CONTRACTOR IS RESPONSIBLE FOR INSURING THAT THIS PROJECT AND RELATED WORK COMPLIES WITH ALL APPLICABLE LOCAL, STATE AND FEDERAL SAFETY CODES AND REGULATIONS GOVERNING THIS
- 9. ALL WORK SHALL BE COMPLETED IN ACCORDANCE WITH THE LATEST EDITION OF THE LOCAL BUILDING CODE.
- 10. ALL PROPOSED CELLULAR EQUIPMENT AND FIXTURES SHALL BE FURNISHED BY OWNER FOR INSTALLATION BY THE CONTRACTOR, UNLESS SPECIFICALLY NOTED OTHERWISE HEREIN
- 11. ACCESS TO THE PROPOSED WORK SITE MAY BE RESTRICTED. THE CONTRACTOR SHALL COORDINATE INTENDED CONSTRUCTION ACTIVITY, INCLUDING WORK SCHEDULE AND MATERIALS ACCESS WITH THE RESIDENT LEASING AGENT FOR APPROVAL.
- 12. RADIO EQUIPMENT INSTALLATION SHALL BE IN ACCORDANCE WITH THE MANUFACTURER'S SPECIFICATIONS.

STRUCTURAL NOTES

- 1. DESIGN REQUIREMENTS PER LOCAL BUILDING CODE AND THE E1A/TIA-222-G STRUCTURAL STANDARDS FOR STEEL ANTENNAS TOWERS AND SUPPORTING STRUCTURES.
- 2. STRUCTURAL STEEL SHALL CONFORM TO THE LATEST EDITION OF A.I.S.C. SPECIFICATIONS FOR STRUCTURAL STEEL BUILDINGS—ALLOWABLE STRESS DESIGN AND PLASTIC DESIGN NCLUDING THE COMMENTARY AND THE A.I.S.C. CODE OF STANDARD PRACTICE
- 3. STRUCTURAL STEEL PLATES AND SHAPES SHALL CONFORM TO ASTM A36. ALL STRUCTURAL STEEL PIPES SHALL CONFORM TO ASTM A53 GRADE 8. ALL STRUCTURAL STEEL TUBING SHALL CONFORM TO ASTM A500 GRACE 8. ALL STRUCTURAL STEEL COMPONENTS AND FABRICATED ASSEMBLIES SHALL BE HOT DIP GALVANIZED AFTER FABRICATION
- WELDING SHALL BE IN ACCORDANCE WITH THE AMERICAN WELDING SOCIETY (AWS) D.1.1-96. STRUCTURAL WELDING CODE-STEEL WELD ELECTRODES SHALL BE E70XX.
- 5. ALL COAXIAL CABLE CONNECTORS AND TRANSMITTER EQUIPMENT SHALL BE AS SPECIFIED BY THE OWNER AND IS NOT INCLUDED IN THESE CONSTRUCTION DOCUMENTS. THE CONTRACTOR SHALL FURNISH ALL CONNECTION HARDWARE REQUIRED TO SECURE THE CABLES. CONNECTION HARDWARE SHALL BE STAINLESS STEEL.
- 6. NORTH ARROW SHOWN ON PLANS REFERS TO TRUE NORTH. CONTRACTOR SHALL VERIFY NORTH AND INFORM OWNER OF ANY DISCREPANCY BEFORE STARTING CONSTRUCTION.
- 7. ALL CAST IN PLACE CONCRETE SHALL BE MIXED AND PLACED IN ACCORDANCE WITH THE REQUIREMENTS OF ACI 318 AND ACI 301, AND SHALL HAVE A 28 DAY MINIMUM COMPRESSIVE STRENGTH OF 3000 PSI (U.O.N.). CONCRETE SHALL BE PLACED AGAINST UNDISTURBED SOIL UNLESS OTHERWISE NOTED. MINIMUM CONCRETE COVER SHALL BE 3 INCHES UNLESS OTHERWISE NOTED.
- ALL REINFORCING STEEL SHALL CONFORM TO ASTM 615 GRADE 80, DEFORMED BILLET STEEL BARS. WELDED WIRE FABRIC REINFORCING SHALL CONFORM TO ASTM A185
- 9. THE FABRICATION AND ERECTION OF STRUCTURAL STEEL SHALL CONFORM TO THE LATEST A.I.S.C. SPECIFICATIONS
- 10. ALL CONNECTIONS NOT FULLY DETAILED ON THESE PLANS SHALL BE DETAILED BY THE STEEL FABRICATOR IN ACCORDANCE WITH
- 11. HOT-DIP GALVANIZE ITEMS SPECIFIED TO BE ZINC-COATED. AFTER FABRICATION WHERE PRACTICAL, GALVANIZING: ASTM A 123, ASTM A 153/A 153M OR ASTM A 653/A 653M, G90, AS
- 12. REPAIR DAMAGED SURFACES WITH GALVANIZING REPAIR METHOD AND PAINT' CONFORMING TO ASTM A 780 OR BY APPLICATION OF STICK OR THICK PASTE MATERIAL SPECIFICALLY DESIGNED FOR REPAIR OF GALVANIZING CLEAN AREAS TO BE REPAIRED, AND REMOVE SLAG FROM WELDS. HEAT SURFACES TO WHICH STICK OR PASTE MATERIAL IS APPLIED WITH A TORCH TO A TEMPERATURE SUFFICIENT TO MELT THE METALLICS. IN STICK OR PASTE, SPREAD MOLTEN MATERIAL UNIFORMLY OVER SURFACES TO BE COATED AND WIPE OFF EXCESS MATERIAL.
- 13. CONTRACTOR SHALL FOLLOW THE MANUFACTURER'S INSTRUCTIONS/ SPECIFICATIONS IF NO INFORMATION IS CONTAINED IN THESE PLANS OR IF THE MANUFACTURER'S SPECIFICATIONS ARE STRICTER.

PERMITS

- CONTRACTOR SHALL SECURE ALL NECESSARY PERMITS FOR THIS PROJECT FROM ALL APPLICABLE GOVERNMENTAL AGENCIES. (NOT SUPPLIED BY OWNER)
- 2. ANY PERMITS WHICH MUST BE OBTAINED SHALL BE THE CONTRACTORS RESPONSIBILITY. THE CONTRACTOR SHALL BE RESPONSIBLE FOR ABIDING BY ALL CONDITIONS AND REQUIREMENTS OF THE PERMITS. (NOT SUPPLIED BY OWNER)
- 3. ALL WORK SHALL BE IN ACCORDANCE WITH LOCAL CODES AND THE LATEST APPLICABLE CODES AND STANDARDS
- THE CONTRACTOR SHALL NOTIFY THE APPLICABLE JURISDICTIONAL (STATE, COUNTY, OR CITY) ENGINEER 24 HOURS PRIOR TO THE BEGINNING OF CONSTRUCTION.
- 5. CONTRACTOR RESPONSIBLE FOR CLOSING AND FILING ALL PERMITS ASSOCIATED WITH SITE.

UTILITIES

- CONTRACTOR SHALL CONTACT A SUBSURFACE UTILITY LOCATOR FOR LOCATION OF EXISTING UTILITIES PRIOR TO COMMENCEMENT OF ANY CONSTRUCTION ACTIVITIES LOCATION OF EXISTING SEWER, WATER LINES, GAS LINES CONDUITS OR OTHER STRUCTURES ACROSS, UNDERNEATH OR OTHERWISE ALONG THE LINE OF PROPOSED WORK ARE NOT NECESSARILY SHOWN ON THE PLANS, AND IF SHOWN ARE ONLY APPROXIMATELY CORRECT. CONTRACTOR
 ASSUMES SOLE RESPONSIBILITY FOR VERIFYING LOCATION AND ELEVATION OF ALL UNDERGROUND UTILITIES (INCLUDING TEST PITS BY HAND IF NECESSARY) IN AREAS OF CONSTRUCTION PRIOR TO STARTING WORK, CONTACT ENGINEER IMMEDIATELY IF LOCATION OR ELEVATION IS DIFFERENT FROM THAT SHOWN ON THE PLANS, OR IF THERE APPEARS TO BE A CONFLICT.
- CONTRACTOR SHALL COORDINATE ALL UTILITY CONNECTIONS WITH APPROPRIATE UTILITY OWNERS AND CONSTRUCTION
- DAMAGE BY THE CONTRACTOR TO UTILITIES OR PROPERTY OF OTHERS, INCLUDING EXISTING PAVEMENT AND OTHER SURFACES DISTURBED BY THE CONTRACTOR DURING CONSTRUCTION SHALL BE REPAIRED TO PRE CONSTRUCTION CONDITIONS BY THE CONTRACTOR AT NO ADDITIONAL COST TO THE CLIENT. FOR GRASSED AREAS, SEED AND MULCH SHALL BE ACCEPTABLE ..
- THE CONTRACTOR SHALL COORDINATE WITH THE OWNER THE REQUIREMENTS FOR AND LIMITS OF OVERHEAD AND/OR UNDERGROUND ELECTRICAL SERVICE.
- 5. THE CONTRACTOR SHALL COORDINATE THE LOCATION OF NEW UNDERGROUND TELEPHONE SERVICE WITH THE TELEPHONE UTILITY AND THE OWNER'S REQUIREMENTS.
- ALL UNDERGROUND UTILITIES SHALL BE INSTALLED AND TESTED SATISFACTORY PRIOR TO COMMENCING ANY PAVING OPERATIONS WHERE SUCH UTILITIES ARE WITHIN THE LIMITS PAVEMENT

GRADING

- THE CONTRACTOR SHALL REWORK (DRY, SCARIFY, ETC...) ALL MATERIAL NOT SUITABLE FOR SUB GRADE IN ITS PRESENT STATE. IF THE MATERIAL, AFTER REWORKING, REMAINS UNSUITABLE THEN THE CONTRACTOR SHALL UNDERCUT THIS MATERIAL AND REPLACE WITH APPROVED MATERIAL AT HIS EXPENSE. ALL SUB GRADES SHALL BE PROOF ROLLED WITH A FULLY LOADED TANDEM AXLE DUMP TRUCK PRIOR TO PAVING. ANY SOFT MATERIAL SHALL BE REWORKED OR REPLACED
- THE CONTRACTOR IS REQUIRED TO MAINTAIN ALL DITCHES. PIPES, AND OTHER DRAINAGE STRUCTURES FREE FROM OBSTRUCTION UNTIL WORK IS ACCEPTABLE BY THE OWNER. THE CONTRACTOR IS RESPONSIBLE FOR ANY DAMAGES CAUSED BY FAILURE TO MAINTAIN DRAINAGE STRUCTURES IN OPERABLE CONDITION.
- 3. ALL MATERIALS AND WORKMANSHIP SHALL BE WARRANTED FOR ONE (1) YEAR FROM DATE OF ACCEPTANCE.
- ALL DIMENSIONS SHALL BE VERIFIED WITH THE PLANS (LATEST REVISION) PRIOR TO COMMENCING CONSTRUCTION. NOTIFY THE OWNER IMMEDIATELY IF DISCREPANCIES ARE DISCOVERED. THE CONTRACTOR SHALL HAVE A SET OF APPROVED PLANS AVAILABLE AT THE SITE AT ALL TIMES WHEN WORK IS BEING PRE FORMED. A DESIGNATED RESPONSIBLE EMPLOYEE SHALL BE AVAILABLE FOR CONTACT BY GOVERNING AGENCY INSPECTORS.

PAINTING

- 1. CONTRACTOR TO COORDINATE PAINTING REQUIREMENTS WITH OWNER
- 2. PAINT COLORS SHALL BE SELECTED TO MATCH EXISTING COLORS AND **TEXTURES**
- PROVIDE THE BEST QUALITY GRADE OF COATINGS AS REGULARLY MANUFACTURED BY APPROVED PAINT MATERIAL MANUFACTURERS, MATERIALS NOT DISPLAYING THE MANUFACTURER'S IDENTIFICATION AS A STANDARD, BEST-GRADE PRODUCT WILL NOT BE ACCEPTABLE.
- PROVIDE UNDERCOAT PAINT PRODUCED BY THE SAME MANUFACTURER AS THE FINISH COATS. USE ONLY THINNERS APPROVED BY THE PAINT MANUFACTURER AND USE ONLY WITHIN RECOMMENDED LIMITS.
- COMPLETELY COVER TO PROVIDE AN OPAQUE, SMOOTH SURFACE OF UNIFORM FINISH, COLOR, APPEARANCE, AND COVERAGE. CLOUDINES:

FERROUS METALS

TOUCH-UP COAT - RED OXIDE METAL PRIMER FINISH COATS - SEMI-GLOSS-ALKYD ENAMEL

SBA CONSTRUCTION REQUIREMENTS

- 1. AWARDED CONTRACTOR WILL BE REQUIRED TO SIGN AND RETURN A COPY OF AN AWARD LETTER FOR SBA'S FILE.
- 2. CONTRACTOR WILL BE REQUIRED TO PROVIDE PROOF OF LICENSE TO PERFORM WORK IN JURISDICTION AT TIME OF BID AWARD.
- CONSTRUCTION STARTING AND WILL PROVIDE UPDATE/CHANGES (WITH EXPLANATIONS) TO THAT SCHEDULE WHEN/IF ITEMS ARE DELAYED OR
- CONTRACTOR WILL BE RESPONSIBLE FOR ALL CONCRETE COMPRESSIVE TESTING AND REQUIRED TO SUBMIT FINAL TEST RESULTS WITH CLOSE
- 5. CONTRACTOR WILL BE RESPONSIBLE TO PROVIDE SBA PROJECT MANAGERS WITH PHOTOS OF THE MAJOR CONSTRUCTION MILESTONES
- AS WELL AS TELCO SERVICE BEFORE PROJECT COMPLETION. (ON SITE VISITS WITH UTILITY COMPANY REPRESENTATIVES AS NECESSARY, ETC).
- CONFERENCE CALL IS HELD EACH AND EVERY THURSDAY AT 4 PM (EASTERN TIME).
- B. CONTRACTOR SHOULD BE PREPARED FOR RANDOM SBA SAFETY INSPECTIONS AT ALL TIMES.
- 9. CONTRACTOR IS EXPECTED TO MAINTAIN PROPER WORKING CONDITIONS AND PROCEDURES PER OSHA STANDARDS AT ALL TIMES.
- CONTRACTOR WILL BE REQUIRED TO OBTAIN THE NECESSARY ELECTRICAL PERMITS AND INSPECTIONS AS REQUIRED BY JURISDICTION.
- AS POSSIBLE (OBTAINING A CERTIFICATE OF OCCUPANCY AND GETTING SBA'S REGIONAL SITE MANAGER'S SIGN-OFF/CHECKLIST APPROVAL ON
- FORM AND TAPE DROP WITHIN 24 HOURS OF REACHING OVERALL
- CHECKLIST, CONSTRUCTION SCHEDULE, CONSTRUCTION CLOSE-OUT LIST & TOWER HEIGHT VERIFICATION.
- 14. CONTRACTOR IS RESPONSIBLE FOR CONCRETE COMPRESSION TESTING

SPOTTINGS, HOLIDAYS, LAPS, BRUSH MARKS, RUNS, SAGS, ROPINESS, OR OTHER SURFACE IMPERFECTIONS WILL NOT BE ACCEPTABLE.



3. CONTRACTOR WILL PROVIDE A CONSTRUCTION SCHEDULE PRIOR TO

- PUSHED OUT.
- AS THEY OCCUR.
- CONTRACTOR WILL BE RESPONSIBLE TO ASSIST IN COORDINATING AND OBTAINING PRIMARY POWER TO THE SITE PRIOR TO TOWER ERECTION,
- CONTRACTOR WILL HAVE A REPRESENTATIVE ON A WEEKLY CONFERENCE CALL TO PROVIDE SBA WITH SITE SPECIFIC UPDATES. CURRENTLY, THIS

- 11. CONTRACTOR IS EXPECTED TO CLOSE-OUT THE JOB SITE AS QUICKLY
- 12. CONTRACTOR WILL PROVIDE A COMPLETED TOWER HEIGHT VERIFICATION
- 13. CONTRACTOR WILL UTILIZE ALL OF THE SBA PROVIDED DOCUMENTATION INCLUDING BUT NOT LIMITED TO: TOWER CONSTRUCTION ACCEPTANCE
- 15. CONTRACTOR IS RESPONSIBLE FOR GROUND MEG TESTING.



 \mathbf{m}

S

LLC. LIABILITY 33487 7-7483 ★라. ★ 등 등 등 등 등 4

SBA TOW DELAWARE 1 CON 00 BROKEN BOCA RATO 00 BROK BOCA I

6 펍 ST PALLSADES BI UNIT # 102 HILLS, ARIZONA / :: (480) 836—170 (480) 836—100, Si O SiinoD FOUNTAIN HILLS, PHONE: (480 PMONE: (480 PMONE: (487 PMONE: (487 PMONE) SD





KEVISIONS	DESCRIPTION	REVIEW	FINAL	REMOVED GENERATOR	CITY COMMENTS				
	DATE	05/10/16	07/12/16	08/05/16	10/14/16	01/23/17	02/28/17	04/11/17	04/20/17
	NO.	A	В	ပ	0	ш	L	S	Ξ

SITE I.D. TX17739-B

ELP CLARK

SITE ADDRESS

SITE NAME

6440 GATEWAY BLVD., # E EL PASO, TX 79905

DRAWN BY:	JN			
CHECKED BY:	٨٦			
DATE:	8/2/16			
PROJECT #:	TBD			

SHEET TITLE:

GENERAL NOTES

SHEET NO.

GN-1

MEMORANDUM ...

DATE:

May 23, 2017

TO:

The Honorable Mayor and City Council

Tommy Gonzalez, City Manager

FROM:

Jeff Howell, Senior Planner

SUBJECT:

PZST16-00026

The City Plan Commission (CPC), on May 4, 2017, voted 6-0 to recommend approval of the special permit to allow for the placement of a ground-mounted personal wireless service facility (PWSF) on the proposed site within one-half mile radius of an existing PWSF site as required by El Paso City Code Section 20.10.455.F.

The CPC found that the special permit is in conformance with Plan El Paso. The CPC also determined that the special permit protects the best interest, health, safety and welfare of the public in general; that the proposed use is compatible with adjacent land uses; and the special permit will have no effect on the natural environment, social economic conditions, and property values in the vicinity and the city as a whole.

The Planning Division did not receive any communication in support or opposition to the special permit request.

Property Owner:

Gregg Michael Seltzer and Julie Paris Seltzer Trust

Applicant:

SBA Towers IX, LLC c/o Shaw & Associates, PLC Jason Sanks, Shaw & Associates, PLC

Representative:

Attachments: Staff Report



City of El Paso - City Plan Commission Staff Report

Case No: PZST16-00026

Application Type: Special Permit and Detailed Site Development Plan

CPC Hearing Date: May 4, 2017

Staff Planner: Jeff Howell, 915-212-1607, howelljb@elpasotexas.gov

Location: 6440 Gateway Boulevard East

Legal Description: A portion of Lot 27, Block 2, Bassett Commercial Complex Unit One, City of El

Paso, El Paso County, Texas

Acreage: 0.014-acre

Rep District: 3

Existing Zoning: C-3/sc (Commercial/special contract)

Existing Use: Commercial/retail

C/SC/SP/ZBA/LNC: Condition imposed through Special Contract by Ordinance No. 5177, dated January

8, 1973

Request: Special Permit to allow a Personal Wireless Service Facility (PWSF) within a one-

half mile distance of an existing PWSF

Proposed Use: Ground-mounted PWSF

Property Owner: Gregg Michael Seltzer and Julie Paris Seltzer Trust

Applicant: SBA Towers IX, LLC

Representative: Jason Sanks, Shaw & Associates, PLC

SURROUNDING ZONING AND LAND USE

North: C-3/sc (Commercial/special contract) / Commercial/retail

South: R-4 (Residential) / Single-family dwellings

East: C-4/sc (Commercial/special contract) / Commercial/retail

West: C-3/sc (Commercial/special contract) / Warehouse, R-4 (Residential) / Single-family dwellings

PLAN EL PASO DESIGNATION: G-4, Suburban (Walkable) (Central Planning Area)

NEAREST PARK: Edgemere Median Park (3,314 feet)

NEAREST SCHOOL: Bonham Elementary School (4,522feet)

NEIGHBORHOOD ASSOCIATIONS

El Paso Central Business Association

NEIGHBORHOOD INPUT

Notice of a Public Hearing was mailed to all property owners within 300 feet of the subject property on April 19, 2017. The Planning Division has not received any communication in support or opposition to the special permit request. Planning did receive one phone call of inquiry.

APPLICATION DESCRIPTION

The applicant is requesting a special permit to allow for the placement of a ground-mounted personal wireless service facility (PWSF) on the proposed site within a one-half mile radius of an existing PWSF site as required by El Paso City Code Section 20.10.455.F. The site plan shows a 600 sq. ft. lease area for a 56'-10" high structure with antennas and service equipment enclosure. The antennas and support structure will be camouflaged to resemble a pine tree, while the equipment will be screened by a walled enclosure at the edge of the property adjacent to an existing building. The proposed PWSF meets all setback and height requirements for location in a commercial district. The applicant opted to request a landscape buyout as permitted by the landscaping ordinance for PWSF facilities. Two nearest PWSF are 0.42 miles to the northeast and is located on Montana Avenue and 0.43 miles to the northeast and is

located on Montana as well. A maintenance access easement within a drive aisle is proposed from Gateway Boulevard East.

The existing conditions on the property as stated in the Special Contract imposed by Ordinance No. 5177, dated January 8, 1973 (*Attachment #9*) have already been satisfied or are not applicable to the proposed personal wireless service facility.

PLANNING DIVISION RECOMMENDATION

The Planning Division recommends **approval** of the special permit for a Personal Wireless Service Facility (PWSF), as it meets all the requirements of 20.10.455 PWSF, 20.04.320, Special Permit, and 20.04.150, Detailed Site Development Plan.

ANALYSIS

20.10.455 Personal Wireless Service Facility (PWSF)

- F. C-3, C-4 and C-5 Commercial Districts.
 - 1. Ground-mounted PWSF antenna support structures with appurtenant equipment storage facilities are permitted with the following restrictions:
 - a. Setbacks. The PWSF antenna support structure shall meet the yard standards of the district, except that a setback of one foot for each foot of height, measured from the PWSF antenna support structure base to any abutting property line of property in a residential or apartment zoning district shall be required. In the case where a right-of-way or easement separates the property from a residential zoning district, the width of such right-of-way or easement shall be included in meeting the setback requirement; provided, however, that the setback from the property line shall never be less than that required in the district yard standards.

The proposed PWSF meets the setback requirement of one foot setback for every one foot of height from the residential property line.

- b. Separation Between PWSF Antenna Support Structures. The minimum separation distance between ground-mounted PWSF antenna support structures shall be one-half mile, except as provided in subsection (F)(1)(c). Separation distance shall be measured by drawing or following a straight line between the base of any existing PWSF antenna support structure and the proposed base of a new PWSF antenna support structure.
- c. Modified Separation Between PWSF Antenna Support Structures. The minimum separation between ground-mounted PWSF antenna support structures may be reduced below one-half mile by city council upon approval of a special permit application if the city council finds that:
 - i. The applicant is reasonably unable to use property that is more than one-half mile from another PWSF antenna support structure and be able to reasonably serve the area designated in a manner that is technically feasible and commercially reasonable;
 - ii. The property on which the PWSF antenna support structure is to be located is the only reasonably available property for use within one-half mile of another PWSF antenna support structure that will enable the applicant to reasonably serve the area designated in a manner that is technically feasible and commercially reasonable;
 - iii. The area designated by the applicant cannot be reasonably served in a manner that is technically feasible and commercially reasonable by locating additional antennas on the applicant's existing PWSF antenna support structures because such existing PWSF antenna support structures cannot safely support additional antennas;

- iv. The applicant is unable to collocate its antennas on an existing PWSF antenna support structure that is owned or operated by a third person or entity and located such that the applicant is able to reasonably serve the area designated in a manner that is technically feasible and commercially reasonable; and
- v. The applicant shall submit a list of addresses/locations showing all existing PWSF within a one-half mile radius of the proposed site and a map depicting such locations with the special permit application.

The applicant has submitted proof that all 5 findings have been met, (see attachment 7).

- d. Height Restriction. The PWSF antenna support structure and appurtenant antennas shall not exceed one hundred twenty-five feet in height, except as provided in subsection (F)(1)(e) or (F)(1)(f).
- e. Modified Height Restriction. If the applicant is collocating two or more antennas on a structure or if the structure is camouflaged, then the height for a PWSF antenna support structure and appurtenant antennas shall not exceed one hundred fifty feet.
- f. Special Permit for Additional Height in C-3 and C-4 Commercial Districts Only. The height for a ground-mounted PWSF antenna support structure and appurtenant antennas may be increased by city council upon approval of a special permit application, if the city council finds that:
 - i. The property on which the PWSF antenna support structure is to be located is the only property reasonably available for use by the applicant for a PWSF antenna support structure of the height being proposed by the applicant that will enable the applicant to reasonably serve the area designated in a manner that is technically feasible and commercially reasonable;
 - ii. The applicant is unable to collocate its antennas on an existing PWSF antenna support structure that is owned or operated by a third person or entity and located such that the applicant is able to reasonably serve the area designated in a manner that is technically feasible and commercially reasonable;
 - iii. The applicant cannot use another PWSF antenna support structure that is located such that will enable the applicant to reasonably serve the area designated in a manner that is technically feasible and commercially reasonable or that the other PWSF antenna support structures used by the applicant will not safely support additional antennas; and
 - iv. Due to topographical conditions, the proposed height of the PWSF antenna support structure is reasonably necessary to enable the applicant to reasonably serve the area designated in a manner that is technically feasible and commercially reasonable.

g. Camouflage and Screening.

- i. All Ground-Mounted PWSF Shall be Camouflaged. Camouflaging is a method of disguising or concealing the appearance of an object by changing its usual color, modifying its shape or locating it in a structure that complements the natural setting, existing and surrounding structures. In the context of this section, camouflaging, includes, but is not limited to, making PWSF antenna support structures resemble manmade trees, locating PWSF antenna support structures in bell steeples or clock towers, or on similar alternative-design mounting structures.
- ii. Metallic Surfaces Shall be Painted to Reduce Glare and Reflections. No exterior paint colors shall be used which have a light reflecting value (LRV) greater than forty percent.

- The LRV of a paint is available from paint manufacturers and it measures the amount of light reflected by a certain color.
- iii. Screening of antennas on PWSF antenna support structures may include the use of existing parapets, walls, or similar architectural elements provided that it is painted and texturized to integrate with the architecture of the surrounding structure.
- iv. Landscaping shall comply with all code requirements for landscaping.
- h. Other Requirements. The following must accompany a request for a building permit or special permit:
 - i. A detailed plan showing the PWSF antennas support, antennas, and equipment in relation to the existing surroundings including screening, fencing, camouflage, off-street parking, and access from the PWSF antennas support site to the nearest public street;
 - ii. A verification letter that all required FAA and FCC approvals have been requested and that site-specific structural engineering and nonionizing electromagnetic radiation (NIER) reports are available on request from the applicant;
 - iii. Satisfactory completion of a certification of compliance for personal wireless service providers issued by the public safety technology office prior to actual use of the proposed facility accompanied by a verification letter that all required Federal Aviation Administration (FAA) and Federal Communications Commission (FCC) approvals have been requested and that site-specific structural engineering and nonionizing electromagnetic radiation (NIER) reports are available on request from the applicant; and
 - iv. The design of related support structures for new PWSF antenna support structures shall incorporate materials, colors, textures, screening, and camouflaging techniques that will blend them to the extent reasonably possible into the natural setting and surrounding structures. The applicant will be required to provide photographs of predevelopment views versus post-development illustrations, at ninety-degree angles for a full three hundred sixty-degree radius, shown to scale. The building official shall review and consider any of the five items above to mitigate negative visual impacts created by the proposed PWSF antenna support structure and may require reasonable revisions necessary to bring the application into compliance with one or more of the five items above.
- i. A six-foot high screening fence or wall of other than chain-link shall be constructed around the base of an antenna support structure to provide for security. The gate which provides access to the antenna support shall remain locked at all times except when being used for access by maintenance personnel. Collocation or installation of additional antennas on an existing antenna support structure shall be permitted after review and approval by the building official of a structural recertification report prepared and sealed by a licensed professional engineer.
- j. The access driveway and off-street parking spaces for use by maintenance vehicles shall be paved as approved by the building official.
- k. Collocation or installation of additional antennas on an existing antenna support structure shall be permitted. A structural recertification report prepared and sealed by a licensed professional engineer shall be required, and such report shall be reviewed and approved by the building official prior to issuance of a building permit.

The application meets the requirements for PWSF.

20.04.320 Special permit approvals.

A. Building and occupancy permits shall not be issued to any building or use identified in this title as requiring a special permit until after approval of such special permit by the city council.

- B. Building and occupancy permits shall not be issued for any building or use identified in this title as requiring an approved detailed site development plan as required by Article III, until such approval has been granted.
- C. No building or occupancy permit may be granted for the erection, rehabilitation, enlargement or demolition of any building in a designated historic area or for any building that is a designated historic landmark until prior approval has been granted by the historic landmark commission.
- D. The city council, after hearing and report by the city plan commission, may approve a special permit upon a finding that the proposed development meets the following minimum requirements necessary to protect the public health, safety and general welfare of the community:
 - 1. The proposed development complies, except to the extent waived, varied or modified pursuant to the provisions of this title, with all of the standards and conditions applicable in the zoning district in which it is proposed to be located; complies with any special standards applicable to the particular type of development being proposed, or to the particular area in which the development is proposed; complies with any special approvals required in connection with such development or area:
 - 2. The proposed development is in accordance with and in furtherance of the plan for El Paso, any special neighborhood plans or policies adopted by the city regarding the development area, or any approved concept plan;
 - 3. The proposed development is adequately served by and will not impose an undue burden upon the public improvements and rights-of-way by which it will be served or benefited, or which exist or are planned for installation within its boundaries or their immediate vicinity. A traffic impact study may be required to determine the effects of the proposed development on the public rights-of-way;
 - 4. Any impacts of the proposed development on adjacent property are adequately mitigated with the design, proposed construction and phasing of the site development;
 - 5. The design of the proposed development mitigates substantial environmental problems;
 - 6. The proposed development provides adequate landscaping and/or screening where needed to reduce visibility to adjacent uses;
 - 7. The proposed development is compatible with adjacent structures and uses;
 - 8. The proposed development is not materially detrimental to the enjoyment or valuation of the property adjacent to the site.
- E. The applicant may request that the city plan commission waive one or more of the criteria based on its no applicability to the proposed development. The city plan commission, upon a recommendation of the planning official, shall make a determination on the no applicability of the criteria and shall render a finding based on such determination, and shall forward their recommendation to city council for final review and approval.

The application meets the requirements for special permit.

20.04.140 When required.

Except as stated herein, a detailed site development plan is required prior to development in a special purpose district or with a special permit application and may be required if a zoning condition exists on a particular piece of property. Detailed site development plans are not required for any projects for development in the Mixed Use District (RMU, GMU and IMU) or for any other projects other than those located in special purpose districts or as otherwise required herein.

Detailed Site Development Plan review is required as part of the special permit application.

20.04.150 Procedure.

D. City plan commission approval. Pursuant to this Code, the city plan commission, in addition to the powers and duties identified in this chapter, shall have final authority on approval of all other detailed site development plans, unless a zoning condition, contract provision, other city code provision or state law require the detailed site development plan to be approved by city council.

- 1. The planning division shall make its recommendations to the city plan commission within thirty days after a complete application is submitted.
- 2. The city plan commission shall hold a public hearing at its regular meeting that is within thirty days from receipt of department recommendations.
- 3. The commission shall consider the following information when approving a proposed detailed site development plan: the boundaries of the tract proposed for development; location and arrangement of structures; determine if the use conforms to applicable zoning regulations, determine if historic landmark commission approval has been granted for architectural design of all structures if located in a historic district and the design conforms to such approval; location of utility rights-of-way and easements and storm water drainage; vehicular and pedestrian ways; on-site parking areas; location of open spaces and landscape planted areas.
- 4. In no instance shall the city plan commission have authority to vary the yard standards applicable to the district.
- 5. The city plan commission shall approve the plan if it complies with all applicable code provisions.

Planning Staff has reviewed the detailed site development plan, and verified that it meets all requirements of Sections 20.04.320, Special Permit, and 20.04.150 Detailed Site Development Plan.

Plan El Paso-Future Land Use Map Designation

All applications for special permit shall demonstrate compliance with the following criteria:

G-4 – Suburban (Walkable): This sector applies to modern single use residential subdivisions and office parks, large schools and parks, and suburban shopping centers. This sector is generally stable but would benefit from strategic suburban retrofits to supplement the limited housing stock and add missing civic and commercial uses.

The purpose of the C-3 (Commercial) district is to provide for establishments providing goods or rendering services which are used in support of the community's trade and service establishments and serving multineighborhoods. It also permits intensities designed to be compatible with each other and to provide for a wide range of types of commercial activity, including light automobile related uses.

COMMENTS:

Planning and Inspections Department – Planning Division - Transportation

No objections to the special permit request.

<u>Planning and Inspections Department – Plan Review</u>

No objections to proposed special permit.

At the time of submittal for building permits the project will need to comply with all applicable provisions of the IBC, Municipal Code, and TAS.

Planning and Inspections Department - Landscaping Division

No objection to proposed special permit per submitted landscape buyout letter.

Planning and Inspections Department - Land Development

- 1. No objections to proposed special permit for PWSF.
- 2. Approval of the site plans by CPC constitutes a determination that the applicant is in compliance with the minimum provisions. Applicant is responsible for the adequacy of such plans, insuring that stormwater is in compliance with ordinances, codes, DSC, and DDM. Failure to comply may require the applicant to seek re-approval of the site plans from CPC.

Texas Department of Transportation

If no changes to the grading plan and proposed development will use existing access driveways on Gateway East Blvd., TxDOT has no comments.

Fire Department

EPFD has no objections.

Sun Metro

Sun Metro does not oppose this request.

El Paso Electric

No objections.

El Paso Water Utilities

Water:

- 1. There is an existing 12-inch diameter water main extending along the south side of Gateway Blvd. East, approximately 5-feet north of and parallel to the southern right-of-way line of Gateway Blvd. East. This water main is available for service.
- 2. There is an existing 8-inch diameter water main extending along the north side of Clark Dr., approximately 5-feet south of and parallel to the northern right-of-way line of Clark Dr. This water main is available for service.
- 3. EPWU records indicate two (1) active 3/4-inch water meter serving the subject property. The service address for these meters is 6430 Gateway East Blvd.
- 4. Previous water pressure from fire hydrant #4302 located approximately 1470-ft east of Geronimo Dr. has yield a static pressure of 110 (psi), a residual pressure of 85 (psi), and a discharge of 919 gallons per minute. The owner should, for his own protection and at his own expense, install at the discharge side of each water meter a pressure regulator, strainer and relief valve, to be set for pressure as desired by the customer. The Lot owner shall be responsible for the operation and maintenance of the above-described water pressure regulating device.

Sanitary Sewer:

5. There is an existing 8-inch diameter sanitary sewer main extending along Clark Dr. The alignment of the sewer main varies at intersection of Clark DR. and Marlow St. This main is available for service.


General:

- 6. Gateway East Blvd. is a Texas Department of Transportation (TxDOT) right-of-way. All proposed water and sanitary sewer work to be performed within Gateway East Blvd. right-of-way requires written permission from TxDOT.
- 7. EPWater requires a new service application to provide additional services to the property. New service applications are available at 1154 Hawkins, 3rd floor and should be made 6 to 8 weeks in advance of construction to ensure water for construction work. A site plan, utility plan, grading and drainage plans, landscaping plan, the legal description of the property and a certificate-of-compliance are required at the time of application. Service will be provided in accordance with the current EPWater Rules and Regulations. The applicant is responsible for the costs of any necessary on-site and off-site extensions, relocations or adjustments of water and sanitary sewer lines and appurtenances.

Attachments

- 1. Zoning Map
- Aerial Map
 Detailed Site Development Plan
 Simulation Pictures
- 5. Project Purpose Statement
- 6. Landscape Buyout Request7. Findings Analysis-1/2 mile separation
- 8. Coverage Map
- 9. Special Contract


ATTACHMENT 1: ZONING MAP

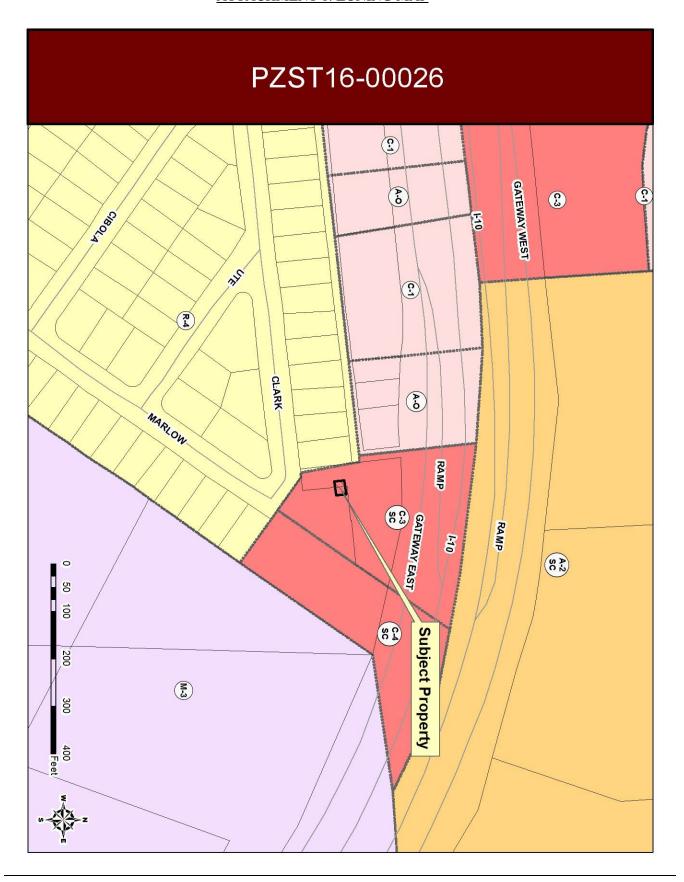



PZST16-00026


Subject Property

ATTACHMENT 3: DETAILED SITE DEVELOPMENT PLAN

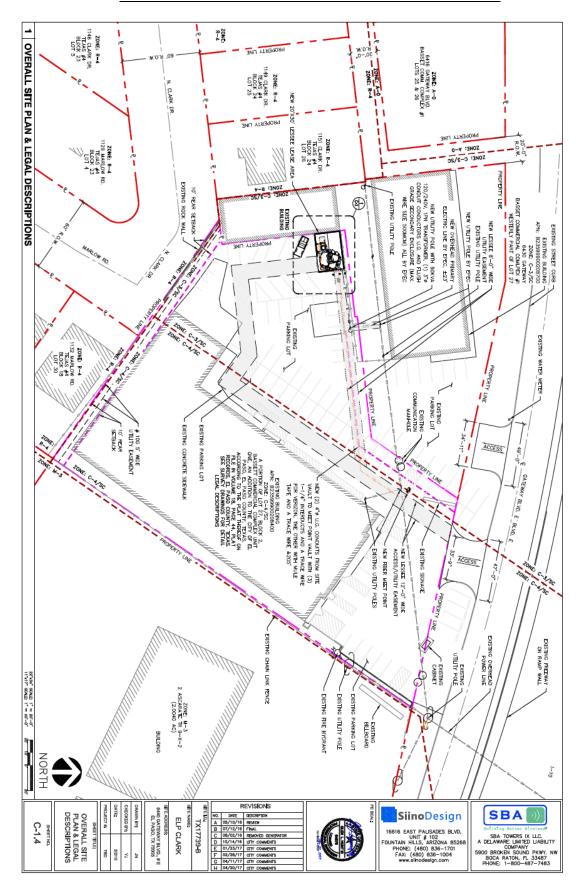

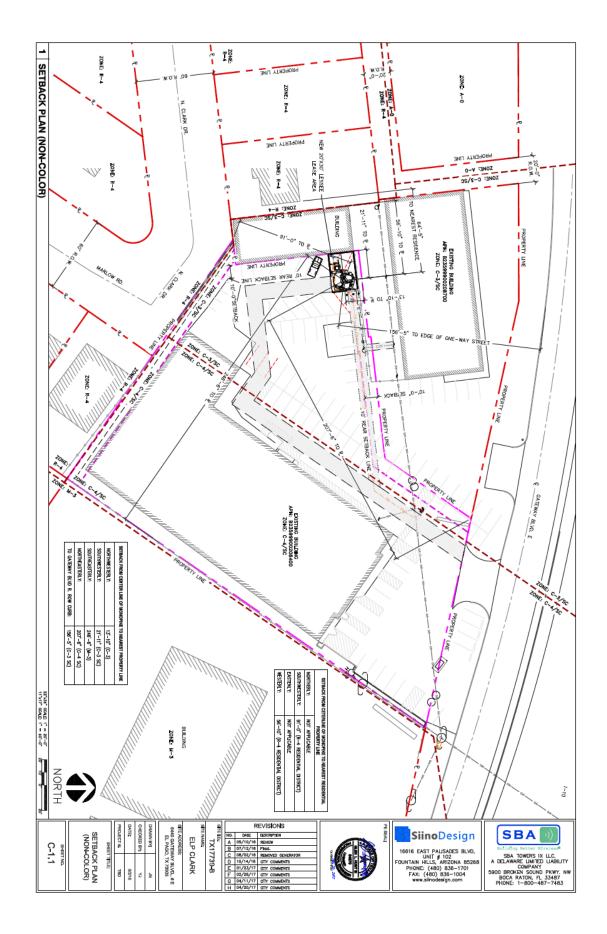


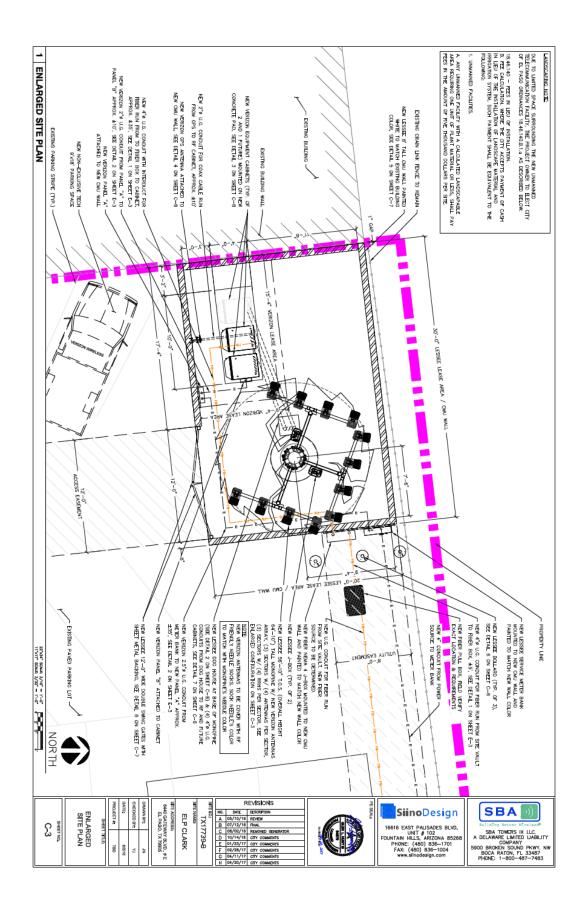

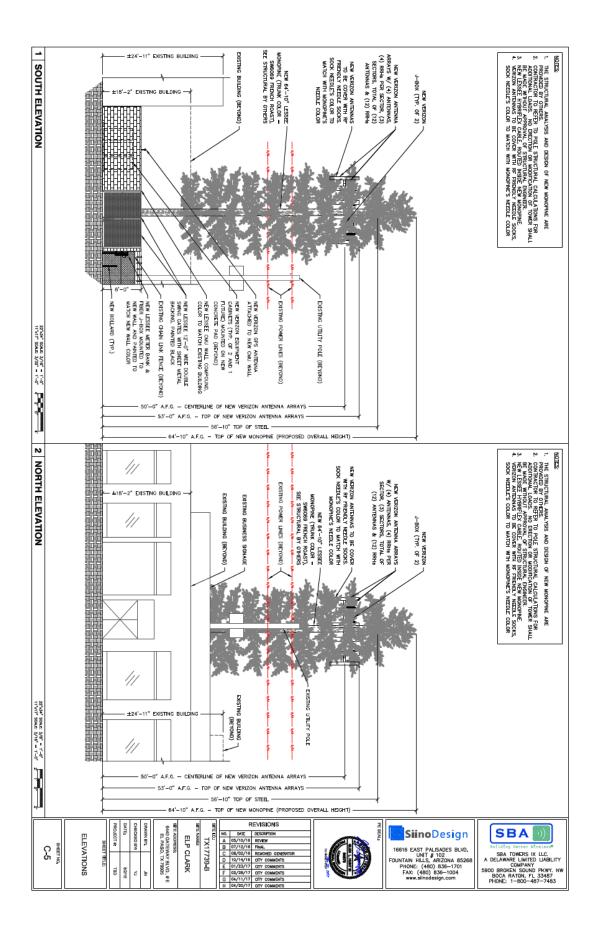

ATTACHMENT 4: SIMULATION PICTURES



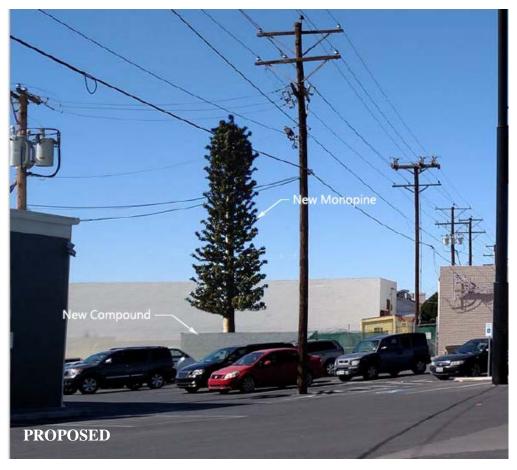













ATTACHMENT 5: PROJECT PURPOSE STATEMENT

Planning and Inspections City of El Paso 300 N Campbell El Paso, TX 79901

Re: Review for a Wireless Service Facility

Applicant: Shaw & Associates, P.L.C. on behalf of SBA Towers

Site Information:

Address: 6440 Gateway Boulevard East

APN: B23599900208400

Owner: Gregg Michael Seltzer and Julie Parish Seltzer Trust

Zoning: C-3/sc and C-4/sc Commercial

Current Use: Commercial retail

Surrounding Uses: North – I-10 corridor; East – M-3 Manufacturing;

South - R-4 Residential: West - R-4 Residential

- 1. <u>General Description of facility</u>: SBA is requesting zoning approval and a Special Permit to construct a wireless communication facility consisting of a 56' 10" foot tall (top of steel) monopine and a 30' x 20' equipment compound on a commercially zoned parcel owned by the Gregg Michael Seltzer and Julie Parish Seltzer Trust.
- 2. <u>Purpose of facility</u>: The general purpose of this wireless communication facility is to provide solutions for wireless service providers. Specifically, SBA has entered into a long term ground lease with the Gregg Michael Seltzer and Julie Parish Seltzer Trust for a multi-tenant wireless communication facility. SBA will shortly enter into and an antenna space sublease with Verizon Wireless, who will be the anchor tenant at the facility. After the tower is constructed, other wireless service providers will be contacted and offered an opportunity to co-locate on the multi-tenant tower in lieu of constructing new verticality in the area.

Verizon Wireless' specific purpose of co-locating on this wireless communication facility is to provide 4th Generation (LTE – high speed wireless internet) capacity offload relief for its surrounding sites and for improved coverage for the numerous surrounding commercial and industrial businesses, Interstate 10, and the nearby residents. This site will enhance voice and data coverage for the ½ mile radius around the site and improve internet speeds for all smart phones or other air card enabled devices that facilitate connectivity to the Verizon Wireless network.

Detailed Description of facility:

a. 56' 10" (top of steel) monopine: As indicated, the proposed tower will be a monopine. A monopine is a monopole that is designed to appear as pine tree. Verizon will mount its twelve antenna array at a height of 50 feet which leaves plenty of co-locatable space on the tower for other wireless service providers. The coaxial cables that connect the antennas to the ground equipment will be entirely enclosed within the interior of the monopine. The monopine will continue to be maintained in accordance with all structural and building requirements of the applicable local, state and federal regulations for the development of wireless telecommunication sites. The monopine will maintain its feature bark texturing/cladding on its exterior to enhance the aesthetics of the pole. SBA will implement Verizon's equipment within the design such that the monopine branches will fully engulf the antenna array. Additionally, the equipment mounted near the branches will be painted to match said branches.

- b. Ground Equipment and Screening: SBA's lease area will be enclosed on the north, east, and south sides by a new 8 foot tall concrete masonry wall. The existing building west of the compound will enclose the equipment on the west side. Therefore, none of SBA's tenant's ground equipment (e.g., Verizon's radio and battery cabinets) will be visible to passersby or citizens and customers utilizing the adjacent parking lot. The monopine itself will be located approximately 156' 5" from the right of way to the north and 246' 6" from the adjacent manufacturing parcel to the east. The nearest residential parcel property line is approximately 56' 10" west of the monopine while the nearest residential structure (single family home) is approximately 64' 5" southwest of the monopine.
- c. Access and Utility Easements: As part of its lease with the Gregg Michael Seltzer and Julie Parish Seltzer Trust, SBA will lease access and utility easement rights to operate the facility. The utility easements will all be underground and the access easement will utilize the existing paved areas on the parcel. These easements are depicted in the site plan and survey attached to this application.
- 4. Other Information: The facility will be unmanned and will generate no refuse. It will have no impact on traffic, water, or sewer services and will not produce any odor. The noise produced by the facility will be limited to the air conditioning units attached to the equipment cabinet. The air conditioning units emit noise equivalent to most single-family residential air conditioning units. The facility is isolated from other buildings thereby minimizing any fire dangers. There should be no demand for police services. All construction methods and materials will be implemented in accordance with all applicable codes and regulations.
- 5. On behalf of SBA I respectfully ask for approval of this project and thank you for your time and consideration of this matter. Please contact me if you have any questions at all about this submittal.

Feasibility Study

Search Area: In order to achieve the coverage and capacity objectives for SBA's anchor tenant, Verizon Wireless (as stated in the narrative), the facility must be located within the area highlighted below in red. According to the Verizon Wireless radiofrequency engineer, the purpose of this site is to provide 4G LTE capacity offload for its ELP Westmoreland site and to improve coverage along the I-10 corridor and the commercial and residential areas in the vicinty of the proposed tower location. The attached RF Significant Gap Statement provided by Verizon's RF engineer provides a statement and a graphic that depicts the nearby Verizon cell sites located to the southeast, west and north of ELP Clark – the graphic further illustrates the specific needs for ELP Clark and moving it a small distance in any direction will interfere with those sites and reduce the effectiveness of ELP Clark.

As can be seen in the below aerial photograph, this search area consists of commercial businesses just south of I-10, mostly manufacturing/industrial uses in the east half of the search area and mostly residential uses in the west half of the search area. The ring is essentially split in half regarding uses: east half consists of heavy industrial use and the west half consists of single family homes with a sliver of commercial use in the north part of the west half. The east half of the ring is vacant industrial land owned by an oil refinery. It is a large area and both Verizon and SBA have contacted the refinery owners numerous times over the past couple of years to place a site on their property. The refinery has been adamant and consistent that it can't allow a cell site on their property due to Homeland Security restrictions.



Existing Verticality: SBA's initial step when searching for a new site on behalf of a wireless service provider is to locate and analyze all existing verticality in the search area. For this particular search area, the existing verticality consists of a number of billboards, 12kv wooden and 69kv metal El Paso Electric utility poles. Said verticality is either of insufficient height and mass to support a cell site installation or simply not colocatable per El Paso Electric internal policy. Said wooden poles are located south of the Gateway Boulevard East right of way and run parallel to the right of way throughout the commercial parcels. The metal poles run along the eastern border of the parent tract of the proposed facility location. The tallest commercial and/or industrial buildings in the search area are insufficient in height to meet Verizon's coverage needs for this area. While SBA's monopine will add additional verticality to this area, the monopine's colocatable attributes will reduce the need for additional towers in the future.



Site Selection: Since there were no existing structures that were available for co-location, the remainder of the search area was canvassed for possible new build options. Three viable candidates were located and all of them are within city of El Paso jurisdiction. The three sites are: 1) Seltzer Trust/Guitar Center, 2) Renata Properties, LLC, and 3) El Paso Board of Realtors. While all three candidates are zoned commercial, the Seltzer Trust/Guitar Center location is preferred by the radiofrequency engineer, offers the most ground space for SBA's facility and provides a decent buffering from the surrounding homes and rights of way (there are existing buildings surrounding the proposed tower location that will substantially conceal SBA's equipment). Additionally, the owner of the Guitar Center property was the most willing to enter into a lease agreement with SBA for a portion of his parcel. See below aerial for the location of these three sites.



The Renata Properties, LLC parcel was made available to SBA by the owner for a stealth tower. This site was not selected, however, because of the limited space that the parcel could offer. The only space available on this parcel for a wireless communications facility would require SBA to utilize the existing parking spaces. If SBA were to construct a site on this parcel, it is possible that the land owner would be in violation of the required number of parking spaces needed to operate a commercial business. Additionally, the facility would ultimately be very visible to passersby along Gateway Boulevard East and I-10 given its proximity to the right of way.

The El Paso Board of Realtors property was vetted as a possible site location for a stealth tower but it was not selected by SBA as it offered less space when compared to the Seltzer Trust/Guitar Center candidate. Additionally, this site would be substantially more visible to passersby along Gateway Boulevard East and I-10 and the nearby homes.

Based on the above discussion, it's clear that the Seltzer Trust/Guitar Center location is the best alternative not only for SBA, but also for the surrounding businesses and homes. The Seltzer Trust/Guitar Center site is located on a commercially zoned property, meets the RF engineer's objectives and is buffered to the north and west by other buildings so that the ground equipment is concealed. This makes it the best choice from a planning perspective. The proposed tower location is located at a distance greater than a 1:1 tower setback from the nearest home.

<u>Compatibility</u>: In addition to the discussion above the Seltzer Trust/Guitar Center site has additional compatibility features that should be highlighted. The ground equipment will be screened on all sides visible to the public by a new concrete masonry wall or exiting buildings and is "tucked away" in a corner of the parking lot that is essentially unusable. The only part of the site that will be visible from nearby rights of way is the top part of the faux pine (see the attached photo simulations taken from the nearest rights of way).

A faux pine design was selected as the best design for this location as the pine tree will blend well with its surroundings and will not damage the fabric of the aesthetic features of the surrounding community. There are numerous live pines in the immediate areas near the property so a monopine was a natural choice for this site. Also, the monopine design offers great flexibility for future carriers to co-locate on the structure – as a matter of fact, the monopine is one of the best designs to promote co-location. Please see before/after photo simulations provided in the application materials.

Note that a clock tower design was not selected at this location mostly due to space issues. A faux clock tower is basically a monopole with walls around it. The clock tower design is a larger structure than a monopine and would have required much more ground space that is not available on this particular property. A clock tower design would have taken additional parking spaces causing the land owner to no longer be in compliance with the required parking. Regarding co-location, a clock tower does not offer the same flexibility for future co-locators as a monopine does. Clock towers can be problematic for carriers whereas the monopine can typically be utilized by all carriers.

The monopine is a better design for this location given the smaller size, the fact that it will blend with the exiting live pine trees and its co-location capabilities.

RF Statement: Please see the attached RF Significant Gap Statement which provides an explanation of the expected coverage of the site. The site will have many positive impacts on network coverage, the most notable of which is indoor/outdoor voice and wireless internet (4G) coverage improvement within ½ mile of the site.

Summary: Locating a site within the boundaries of a RF engineered search area helps to avoid the need for additional sites. Such additional sites are often needed to fill in gaps created by less than optimal initial site locations. In this case, the proposed Seltzer Trust/Guitar Center lease area is an optimal location for this search area since it is within the search area boundaries, is compatible with the surrounding area, and provides a colocatable tower for other carrier's needs in the future. This site will enhance voice and data coverage for the ½ mile radius around the site and improve internet speeds for all smart phones or other air card enabled devices that facilitate connectivity to SBA's tenant's networks.

ATTACHMENT 6: LANDSCAPE BUYOUT REQUEST

RE: Request for Special Permit Approval SBA Tower Site/ID: Clark/TX17739-B

PID: B23599900208400

Address: 6440 Gateway Blvd East, El Paso, TX 79905

Dear Mr. Howell,

SBA has chosen the one time buy out fee of \$5,000.00 for unmanned facilities under Chpater 18.46.140 for said property listed above. The one time buy out fee is in lieu of the requirement to provide 15% landscaping coverage with associated watering system on the lease area portion of the subject parcel.

SBA will submit said payment at the appropriate request from City of El Paso staff.

Please feel free to contact me with any questions or concerns directly at 318-218-8192 or cspiegel@shaw-associates.com

Sincerely,

Casey Spiegel

ATTACHMENT 7: FINDINGS ANALYSIS


- i. The applicant is reasonably unable to use property that is more than one-half mile from another PWSF antenna support structure and be able to reasonably serve the area designated in a manner that is technically feasible and commercially reasonable;
 - i. VZW is unable to utilize either of the existing towers indicated on the ELP Clark .5 Mile Radius Map (noted as 6560 Montana and 6596 Montana) as they are not within the "Search Ring" identified by VZW's engineers. Both are nearly a half mile too far north from this specific geographic area to provide additional capacity (.47 miles), one is already operated by Verizon and will work in tandem with our proposed facility to provide service to our customers. Neither of those facilities can be modified to provide the much needed 4G LTE capacity offload for the VZW ELP Westmoreland site.
- ii. The property on which the PWSF antenna support structure is to be located is the only reasonably available property for use within one-half mile of another PWSF antenna support structure that will enable the applicant to reasonably serve the area designated in a manner that is technically feasible and commercially reasonable;
 - ii. VZW has searched the service area for several months for the best location to add network enhancements. For this particular search area, the existing verticality consists of a number of billboards, 12kv wooden and 69kv metal El Paso Electric utility poles. Said verticality is either of insufficient height and mass to support a cell site installation or simply not colocatable per El Paso Electric internal policy. Nearly 4/5ths of the property within our Search Ring is comprised of single family homes or the Western Refining facility all of which is unavailable for site location. That said, we were tasked with proposing a new PWSF in the form of a "monopine" on the commercial property on the far north end of the search ring. A "clock tower" design will not work in this location due to size and ground space constraints. Also, co-location is more feasible on a monopine rather than a clock tower which will not work for all carriers.
- iii. The area designated by the applicant cannot be reasonably served in a manner that is technically feasible and commercially reasonable by locating additional antennas on the applicant's existing PWSF antenna support structures because such existing PWSF antenna support structures cannot safely support additional antennas;
 - iii. This proposed PWSF is designed to provide extra capacity within the VZW wireless network for the existing ELP Westmoreland site. Refer to VZW's Radio Frequency Engineer's map for adjacent VZW sites in the vicinity. Installing additional antennas at the ELP Westmoreland site will not adequately increase the capacity and coverage service in the immediate area.

- iv. The applicant is unable to collocate its antennas on an existing PWSF antenna support structure that is owned or operated by a third person or entity and located such that the applicant is able to reasonably serve the area designated in a manner that is technically feasible and commercially reasonable; and
 - iv. The relative location of this property makes it unique for the purposes of locating a PWSF based on the need for strict adherence to the grid plan. Engineers at VZW have identified the need for a PWSF within the City of El Paso. Based on a computerized engineering study considering local population density, topography, and traffic along the I-10 corridor, engineers at VZW have issued a "Search Ring" as identified in the submitted ELP Clark Feasibility Study. The Search Ring represents the area in which a facility must be located to allow it to function as an integral part of the wireless network system in the State of Texas and the El Paso area. PWSF facilities are laid out in a grid pattern and the spacing, height and location of this component site are critical for the successful operation of the network. The subject property meets the engineering criteria for the necessary PWSF in this area. If the strict letter of the regulations were carried out, the PWSF could not be constructed due to the separation distance of one-half mile. Please note that we are very close to meeting this requirement as we are .47 miles away from the nearest other PWSF. The hardship has resulted from the need to located a PWSF within the grid pattern at a height that is necessary for antennas to receive and transmit signals. The hardship is also a result of wireless technology and has not been created by any person having an ownership interest in the property. Please also note that nearly half of the Search Area is controlled by Western Refining who it uninterested in hosting a PWSF site due to security concerns. Nearly the entire other half of the Search Ring is comprised of single-family residential homes, making site location all the more difficult.
- v. The applicant shall submit a list of addresses/locations showing all existing PWSF within a one-half mile radius of the proposed site and a map depicting such locations with the special permit application.
 - Refer to ELP Clark 0.5 mile radius map for the two existing PWSFs located within a .5 miles from this proposed PWSF.




- 6560 Montana located app. 0.42 miles from proposed ELP Clark (Verizon's ELP Montana site)
- 2) 6596 Montana located app. 0.43 miles from proposed ELP Clark

ATTACHMENT 8: COVERAGE MAP

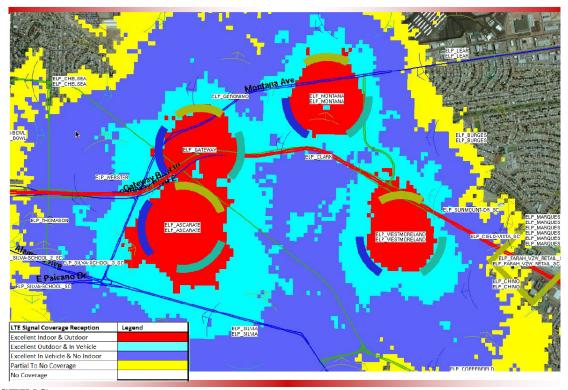

EXISTING

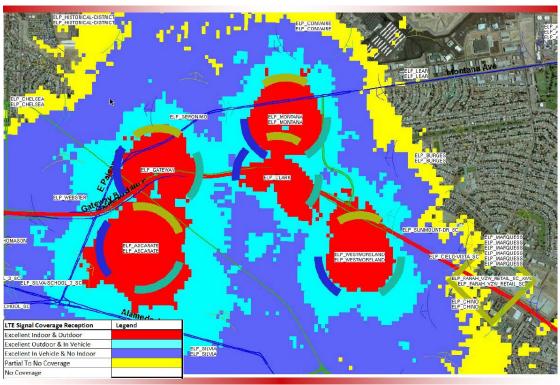

PROPOSED

ATTACHMENT 9: SPECIAL CONTRACT

OF LOT 27, BLOCK 2, BASSETT COM-MERCIAL COMPLEX, THE PENALTY BE-ING AS PROVIDED IN SECTION 25-10 OF THE EL PASO CITY CODE

BE IT ORDAINED BY THE CITY COUNCIL OF THE CITY OF EL PASO:

That the zoning of Lot 27, Block 2, Bassett Commercial Complex be changed to C-3 within the meaning of the Zoning Ordinance, and the zoning map of the City be revised accordingly.

00. 1- 3773 ertify that the zoning map has been rovised to

CONTRACT

Application has been made to the CITY OF EL PASO for rezoning of Lot 27, Block 2, Bassett Commercial Complex Unit 1, in the City of El Paso, El Paso County, Texas.

In order to remove certain objections to such rezoning,
First Parties covenant that if the property is rezoned to C-3

(commercial) within the meaning of the Zoning Ordinance of the
City of El Paso, it shall be subject to the following restrictions:

- First Parties shall, at no cost to the City, do the following:
 - (a) Install a concrete sidewalk along the property line adjacent to Gateway Boulevard East.
 - (b) Install a 6-foot high masonry wall along the westerly and southerly property lines.
 - (c) Pave the entire width of the north-south portion of the alley in Block 2, Bassett Commercial Complex Unit 1, adjacent to the westerly property line.
- 2. The above improvements shall be made in accordance with plans and specifications to be approved by the City Engineer of the CITY OF EL PASO and must be completed by First Parties and approved by the City Engineer prior to the issuance of certificates of occupancy and compliance for any buildings constructed on the property.

This agreement is a restriction, condition and covenant running with the land and a charge and servitude thereon, and shall bind First Parties and their successors in title. Any future conveyance of the land shall contain this restriction, condition and covenant and shall embody this agreement by express reference.

The City may enforce this agreement by injunction or any other legal or equitable remedy. The City Council of the CITY OF EL PASO may release the above restrictions, conditions and covenants in its discretion without the consent of any third person who may be benefited thereby.

WITNESS the following signatures and seals:

	JACKIE F. CRAWFORD
ATTEST:	THE BANK OF EL PASO, formerly CHELMONT STATE BANK, a corporation, Trustee By from President
ATTEST: LANGUE Circle Circle Clerk	By Mayor
THE STATE OF TEXAS) COUNTY OF EL PASO)	

BEFORE ME, the undersigned authority, on this day personally appeared JACKIE F. CRAWFORD, known to me to be the person whose name is subscribed to the foregoing instrument, and acknowledged to me that she executed the same for the purposes and consideration therein expressed.

GIVEN UNDER MY HAND AND OFFICIAL SEAL this day of 1973.

My commission expires: NOTARY PUBLIC, El Paso County, Texas.

THE STATE OF TEXAS)

COUNTY OF EL PASO)

BEFORE ME, the undersigned authority, on this day personally appeared A. C. DONELL, President of THE BANK OF EL PASO, formerly CHELMONT STATE BANK, a corporation, known to me to be the person whose name is subscribed to the foregoing instrument, and acknowledged before me in my county aforesaid that the same was the act of said corporation, and that he executed the same as the act of such corporation for the purposes and consideration therein expressed, and in the capacity therein stated.

THE STATE OF TEXAS COUNTY OF EL PASO

BEFORE ME, the undersigned authority, on this day personally appeared FRED HERVEY, Mayor of the CITY OF EL PASO, known to me to be the person and officer whose name is subscribed to the foregoing instrument, and acknowledged before me in my county aforesaid that he had executed the same for the purposes and consideration and in the capacity therein expressed, and as the act and deed of the CITY OF EL PASO.

GIVEN UNDER MY HAND AND OFFICIAL SEAL this 6th day of

My commission expires: June 1, 1975.

> SRLIE KAN ERANHAM, Novery Public In and rur the County of El Paso, Texas My Commission Expires June 1, 1975

Texas.



Recommendation/Public Input


- Planning Division recommendation: Approval
- CPC Vote: Approval Recommendation (6-0)
- Public Input: No communication in support or opposition to the Special Permit request.

Strategic Goal #3 Promote the Visual Image of El Paso

3.1 Provide business friendly permitting and inspection processes 3.2 Improve the visual impression of the community






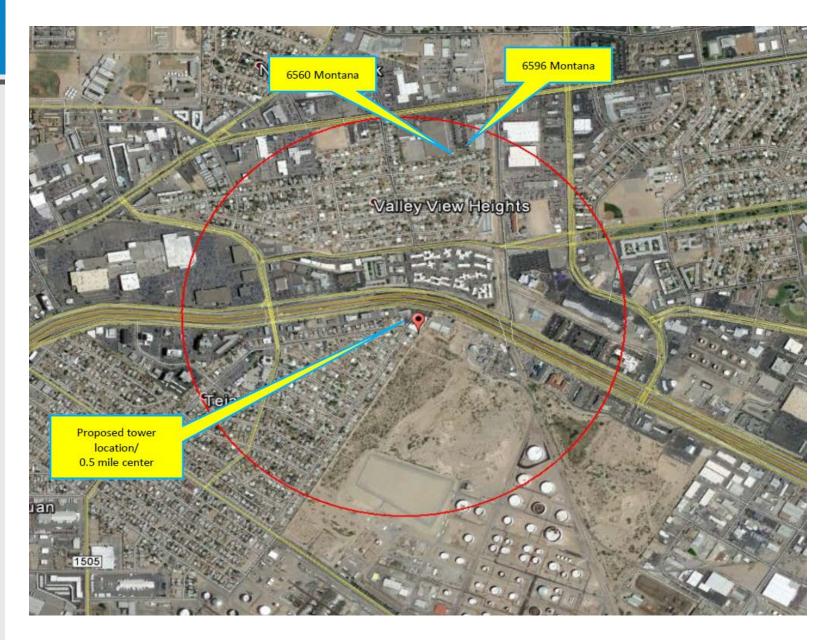






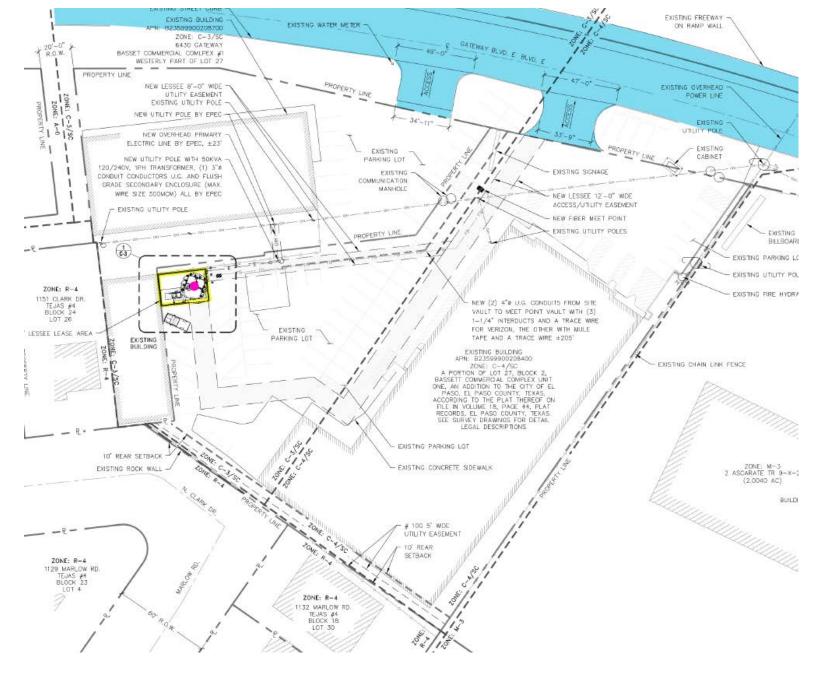



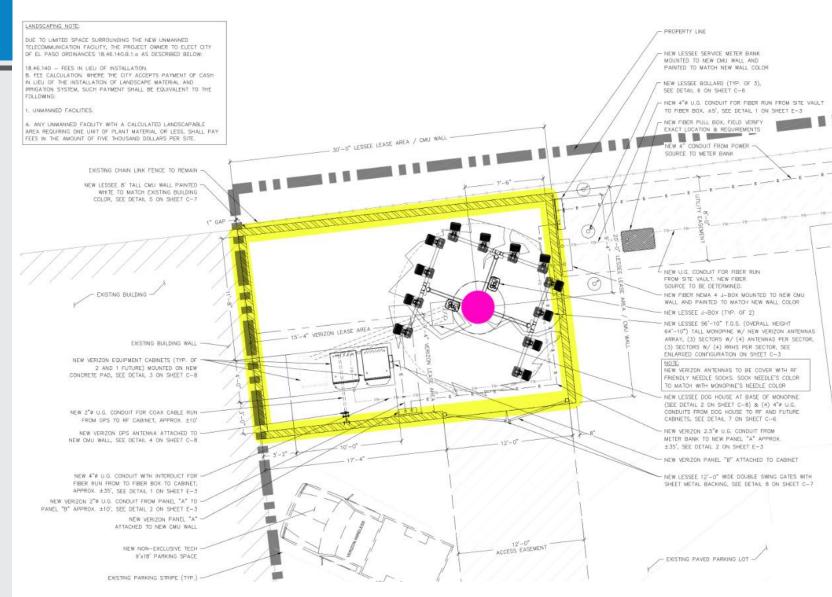







- THE STRUCTURAL ANALYSIS AND DESIGN OF NEW MONOPINE ARE
- THE DESCRIPTION OF THE PROPERTY OF THE WORKSHIP OF THE PROPERTY OF THE PROPERT
- SOCK NEEDLE'S COLOR TO MATCH WITH MONOPINE'S NEEDLE COLOR

- THE STRUCTURAL ANALYSIS AND DESIGN OF NEW MONOPINE ARE
- PROMDED BY OTHERS.
 CONTRACTOR TO REFER TO POLE STRUCTURAL CALCULATIONS FOR ADDITIONAL LOADS. NO ERECTION OR MODIFICATION OF TOMER SHALL. BE MADE WITHOUT APPROVAL OF STRUCTURAL ENGINEER.
 NEW LESSEE HYBRIFLEX CABLE, ROUTED INSIDE NEW MONEPINE.
 VERIZON ANTENNAS TO BE COVER WITH RF FRIENDLY NEEDLE SOCKS,
- SOCK NEEDLE'S COLOR TO MATCH WITH MONOPINE'S NEEDLE COLOR

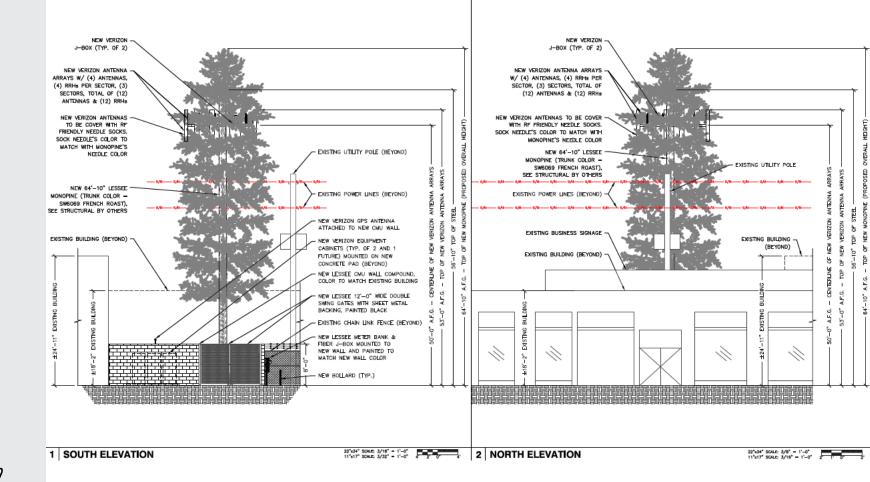



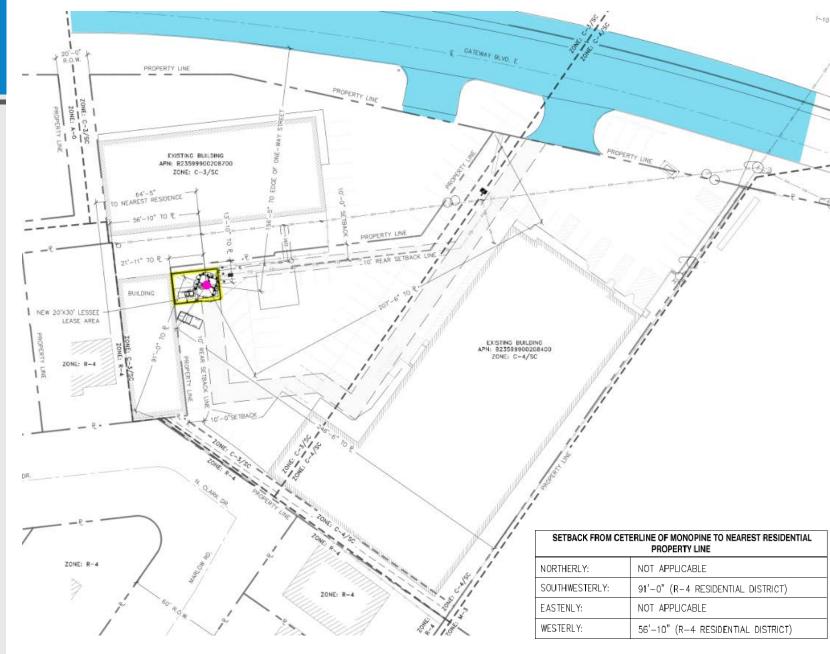



"Delivering Outstanding Services"





Existing









Existing

10 Pr

Proposed





Existing

11 Proposed





Existing









14



"Delivering Outstanding Services"